# Proposed Multi-Storey Residential Development

2345-2349 Highway #2, Bowmanville, ON





#### **DRAWING LIST**

FUNCTIONAL GRADING PLAN FUNCTIONAL SERVICING PLAN **EROSION AND SEDIMENTATION CONTROL** 

#### SITE ELECTRICAL

ELECTRICAL SITE PLAN SITE PLAN LIGHTING ANALYSIS


LANDSCAPE DETAILS

GROUND FLOOR TYPICAL FLOOR 2-3 TYPICAL FLOOR 4-9 PENTHOUSE FLOOR -10 ROOF TOP AMENITY **ELEVATIONS-1 ELEVATIONS-2 BUILDING SECTION** 3D VIEW FROM SOUTH-WEST 3D VIEW FROM NORTH-EAST SHADOW IMAPCT ANALYSIS AREA PLANS-PHASE 1 AREA PLANS-PHASE 2

NAME OF PRACTICE: BARRY BRYAN ASSOCIATES **CERTIFICATE OF PRACTICE NUMBER: 5192** 250 WATER STREET, SUITE 201 WHITBY, ONTARIO, CANADA. LIN 0G5 TEL: (905) - 666 - 5252 (Toronto) (905) - 427 - 4495 FAX: (905) - 666 - 5256

**LOCATION OF PROJECT:** Hwy 2 and Green Rd, Bowmanville

3.00 3.01		Data Matrix Part 3	
	Building Code Version Project Type:	on: O. Reg. 332/12 Last Amendment: O.Reg 79/18  ✓ New   Addition   Renovation	[A] 1.1.2.
		☐ Change of use ☐ Addition and Renovation	[ 4 · · · · =
)2		Description            Occupancy         Use	3.1.2.1.(1)
	Occupancy Classification:	C	
3	Superimposed Major Occupancies:		3.2.2.7
)4	Building Area (m <sup>2</sup> )	Description Existing New Total	[A] 1.4.1.2.
		- <u>- 2369.2</u> <u></u>	
		<u> </u>	
05	Gross Area (m <sup>2</sup> )	DescriptionExistingNewTotalGROUND2369.22369.2	[A] 1.4.1.2.
		2ND FLOOR         2193.2         2193.2           3RD FLOOR         2193.2         2193.2	
	<u> </u>	4TH FLOOR     1893.2     1893.2       5TH FLOOR     1893.2     1893.2       6TH FLOOR     1893.2     1893.2	
		7TH FLOOR 1893.2 1893.2 8TH FLOOR 1893.2 1893.2	
		9TH FLOOR 1893.2 1893.2	
		10TH FLOOR 1459.2 1459.2 734.2 734.2	
	<u> </u>	Total= 20308 (Excludes mezzanine)	
06	Mezzanine Area	Description Syleting New Total	3.2.1.1
00	(m <sup>2</sup> )	DescriptionExistingNewTotalTownhouse Mezzanine Floor-867.2-Mezzanine Storage-345.7-	3.2.1.1
07	Building Height		[A] 1.4.1.2 &
.08	High Building	✓ Yes □ No	3.2.1.1
09	Number of streets/ fire fighter access:	street(s)	3.2.2.10 & 3.2.5
.10	•	3.2.2.42 Group/ Div. C	3.2.2.20 83
11	Sprinkler System	☑ Required ☐ Not Required	3.2.1.5 & 3.2.2.17
		Proposed: ☑ entire building ☐ selected compartments ☐ selected floor areas ☐ basement	
		☐ in lieu of roof rating ☐ none	
.12	11 ,	☐ Required ☐ Not Required ☐ Not Required ☐ Not Required	3.2.9 3.2.4
.14	,	✓ Yes □ No	0.2.4
.15		Restriction: □Combustible Permitted ☑Non-combustible Required	3.2.2.20 83
	Actual construction	Actual: ☐Combustible ☐Non-combustible ☐Combination  Heavy Timber Construction: ☐No ☐Yes	& 3.2.1.4
.16	Importance Category:	□ Low □ Low human Occupancy □ Post-disaster shelter	4.1.2.1. (3) & T4.1.2.1.B
	Category.	<ul><li>✓ Normal</li><li>☐ High</li><li>☐ Minor storage building</li><li>☐ Explosives or hazardous substances</li></ul>	11112113
3.17	Seismic	☐ Post-disaster  (I <sub>E</sub> Fa Sa (0.2))=	4.1.2.1. (3)
	Hazard Index:	Seismic design required for Table 4.1.1.18. items 6 to 21:	4.1.8.18.(2)
.18	Occupant Load:	((I Fa Sa (0.2))> or = 0.35 or Post-disaster) □No □Yes  Floor Level/ Area Occupancy Type Based On Occup. Load	3.1.17.1(2)
	<u> </u>		
19	Barrier-free Design:	<ul><li>✓ Yes Explanation</li><li>☐ No</li></ul>	3.8
	Barrier-free Design: Hazardous Substances:	□ No □ Yes Explanation	3.8 3.3.1.2 & 3.3.1.19
.20	Hazardous Substances:	□ No □ Yes Explanation □ No □ No □ Horizontal Assembly Rating Supporting Non combustible	3.3.1.2 & 3.3.1.19 3.2.2.20 83
.20	Hazardous Substances:	□ No  □ Yes Explanation □ No  Horizontal Assembly Rating Supporting Non combustible in lieu of rating? Floors over basement 2hr 2hr □ No □ Yes □ N/A Floors □ No □ Yes □ N/A	3.3.1.2 & 3.3.1.19
	Hazardous Substances: Required Fire Resistance	□ No □ Yes Explanation □ No □ No □ Horizontal Assembly Rating Supporting Non combustible in lieu of rating? Floors over basement 2hr 2hr □ No □ Yes □ N/A	3.3.1.2 & 3.3.1.19 3.2.2.20 83
.20	Hazardous Substances: Required Fire Resistance Ratings:	□ No   □ Yes Explanation   ☑ No     Horizontal Assembly Assembly (H) Rating Supporting In lieu of rating?   Floors over basement Floors 2hr 2hr No □ Yes □ N/A   Floors 1hr 1hr 1hr No □ Yes □ N/A   Mezzanine Arof 1hr 1hr 1hr No □ Yes □ N/A   Roof 1hr 1hr 1hr No □ Yes □ N/A	3.3.1.2 & 3.3.1.19 3.2.2.20 83
.20	Hazardous Substances: Required Fire Resistance Ratings:	□ No   □ Yes Explanation   ☑ No     Horizontal Assembly Assembly (H) Rating Supporting in lieu of rating?   Floors over basement Floors 2hr 2hr No □ Yes □ N/A   Floors over basement Floors 1hr 1hr □ No □ Yes □ N/A   Mezzanine 1hr 1hr □ No □ Yes □ N/A	3.3.1.2 & 3.3.1.19 3.2.2.20 83 & 3.2.1.4
21	Hazardous Substances:  Required Fire Resistance Ratings:  Spatial Separation:  Wall Area	□ No         □ Yes Explanation	3.3.1.2 & 3.3.1.19 3.2.2.20 83 & 3.2.1.4
20	Hazardous Substances:  Required Fire Resistance Ratings:  Spatial Separation:  Wall Area Of EBF (m²)  North -  South -	□ No         □ Yes Explanation	3.3.1.2 & 3.3.1.19 3.2.2.20 83 & 3.2.1.4
20	Hazardous Substances:  Required Fire Resistance Ratings:  Spatial Separation:  Wall Area Of EBF (m²)  North -	□ Yes       Explanation         ☑ No       Horizontal Assembly       Rating       Supporting       Non combustible in lieu of rating?         Floors over basement Floors       2hr       2hr       □ No       □ Yes       ☑ N/A         Mezzanine Roof       1hr       1hr       1hr       □ No       □ Yes       ☑ N/A         L.D. L/H Permitted (m)       Proposed Openings       FRR (Hours)       Noncombustible construction       Combustible construction w/noncombustible cladding         21       -       100       -       -       -       -	3.3.1.2 & 3.3.1.19 3.2.2.20 83 & 3.2.1.4
.20	Hazardous Substances:  Required Fire Resistance Ratings:  Spatial Separation:  Wall Area Of EBF (m²)  North - South - East - West -	□ Yes         Explanation           ☑ No         Horizontal Assembly Assembly (H)         Rating Supporting in lieu of rating?           Floors over basement Floors         2hr 2hr 1hr 1hr 1hr 1hr 1hr 1hr 1hr 1hr 1hr 1	3.3.1.2 & 3.3.1.19  3.2.2.20 83 & 3.2.1.4
22	Hazardous Substances:  Required Fire Resistance Ratings:  Spatial Separation:  Wall Area Of EBF (m²)  North - South - East -	□ No           □ Yes	3.3.1.2 & 3.3.1.19 3.2.2.20 83 & 3.2.1.4
22	Hazardous Substances:  Required Fire Resistance Ratings:  Spatial Separation:  Wall Area Of EBF (m²)  North - South - East - West -  Plumbing Fixture	□ No  □ Yes Explanation □ No  Horizontal Assembly Rating Supporting in lieu of rating? Floors over basement Short	3.3.1.2 & 3.3.1.19  3.2.2.20 83 & 3.2.1.4
22	Hazardous Substances:  Required Fire Resistance Ratings:  Spatial Separation:  Wall Area Of EBF (m²)  North - South - East - West -  Plumbing Fixture	□ No  □ Yes Explanation □ No  Horizontal Assembly Assembly (H) Floors over basement Floors	3.3.1.2 & 3.3.1.19  3.2.2.20 83 & 3.2.1.4
22	Hazardous Substances:  Required Fire Resistance Ratings:  Spatial Separation:  Wall Area Of EBF (m²)  North - South - East - West -  Plumbing Fixture Requipments:	No	3.3.1.2 & 3.3.1.19  3.2.2.20 83 & 3.2.1.4
.20	Hazardous Substances:  Required Fire Resistance Ratings:  Spatial Separation:  Wall Area Of EBF (m²)  North - South - East - West -  Plumbing Fixture	□ No  □ Yes Explanation □ No  Horizontal Assembly (H) Floors over basement 2hr 2hr 1hr 1hr 1hr 1hr 1hr 1hr 1hr 1hr 1hr 1	3.3.1.2 & 3.3.1.19  3.2.2.20 83 & 3.2.1.4
21 22 23	Hazardous Substances:  Required Fire Resistance Ratings:  Spatial Separation:  Wall Area Of EBF (m²)  North - South - East - West -  Plumbing Fixture Requipments:	No	3.3.1.2 & 3.3.1.19  3.2.2.20 83 & 3.2.1.4

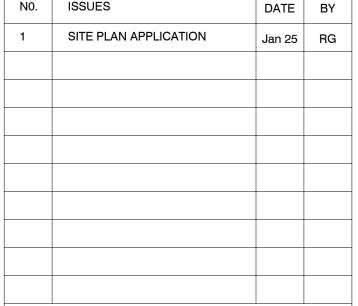

# esidential Proposed



Project No. 20088

**A000** 

Architectural/Structural



PLANNERS:




849 Gorham Street Newmarket, Ontario Canada L3Y 1L7 Phone: (905) 895-0554 Toll Free: (888) 854-0044 www.larkinplus.com





1600 Stellar Drive, Suite 402 Whitby, Ontario L1N 9B2 Tel: (289) 315-3680 Fax: (905) 794-0600


**ELECTRICAL / MECHANICAL:** 




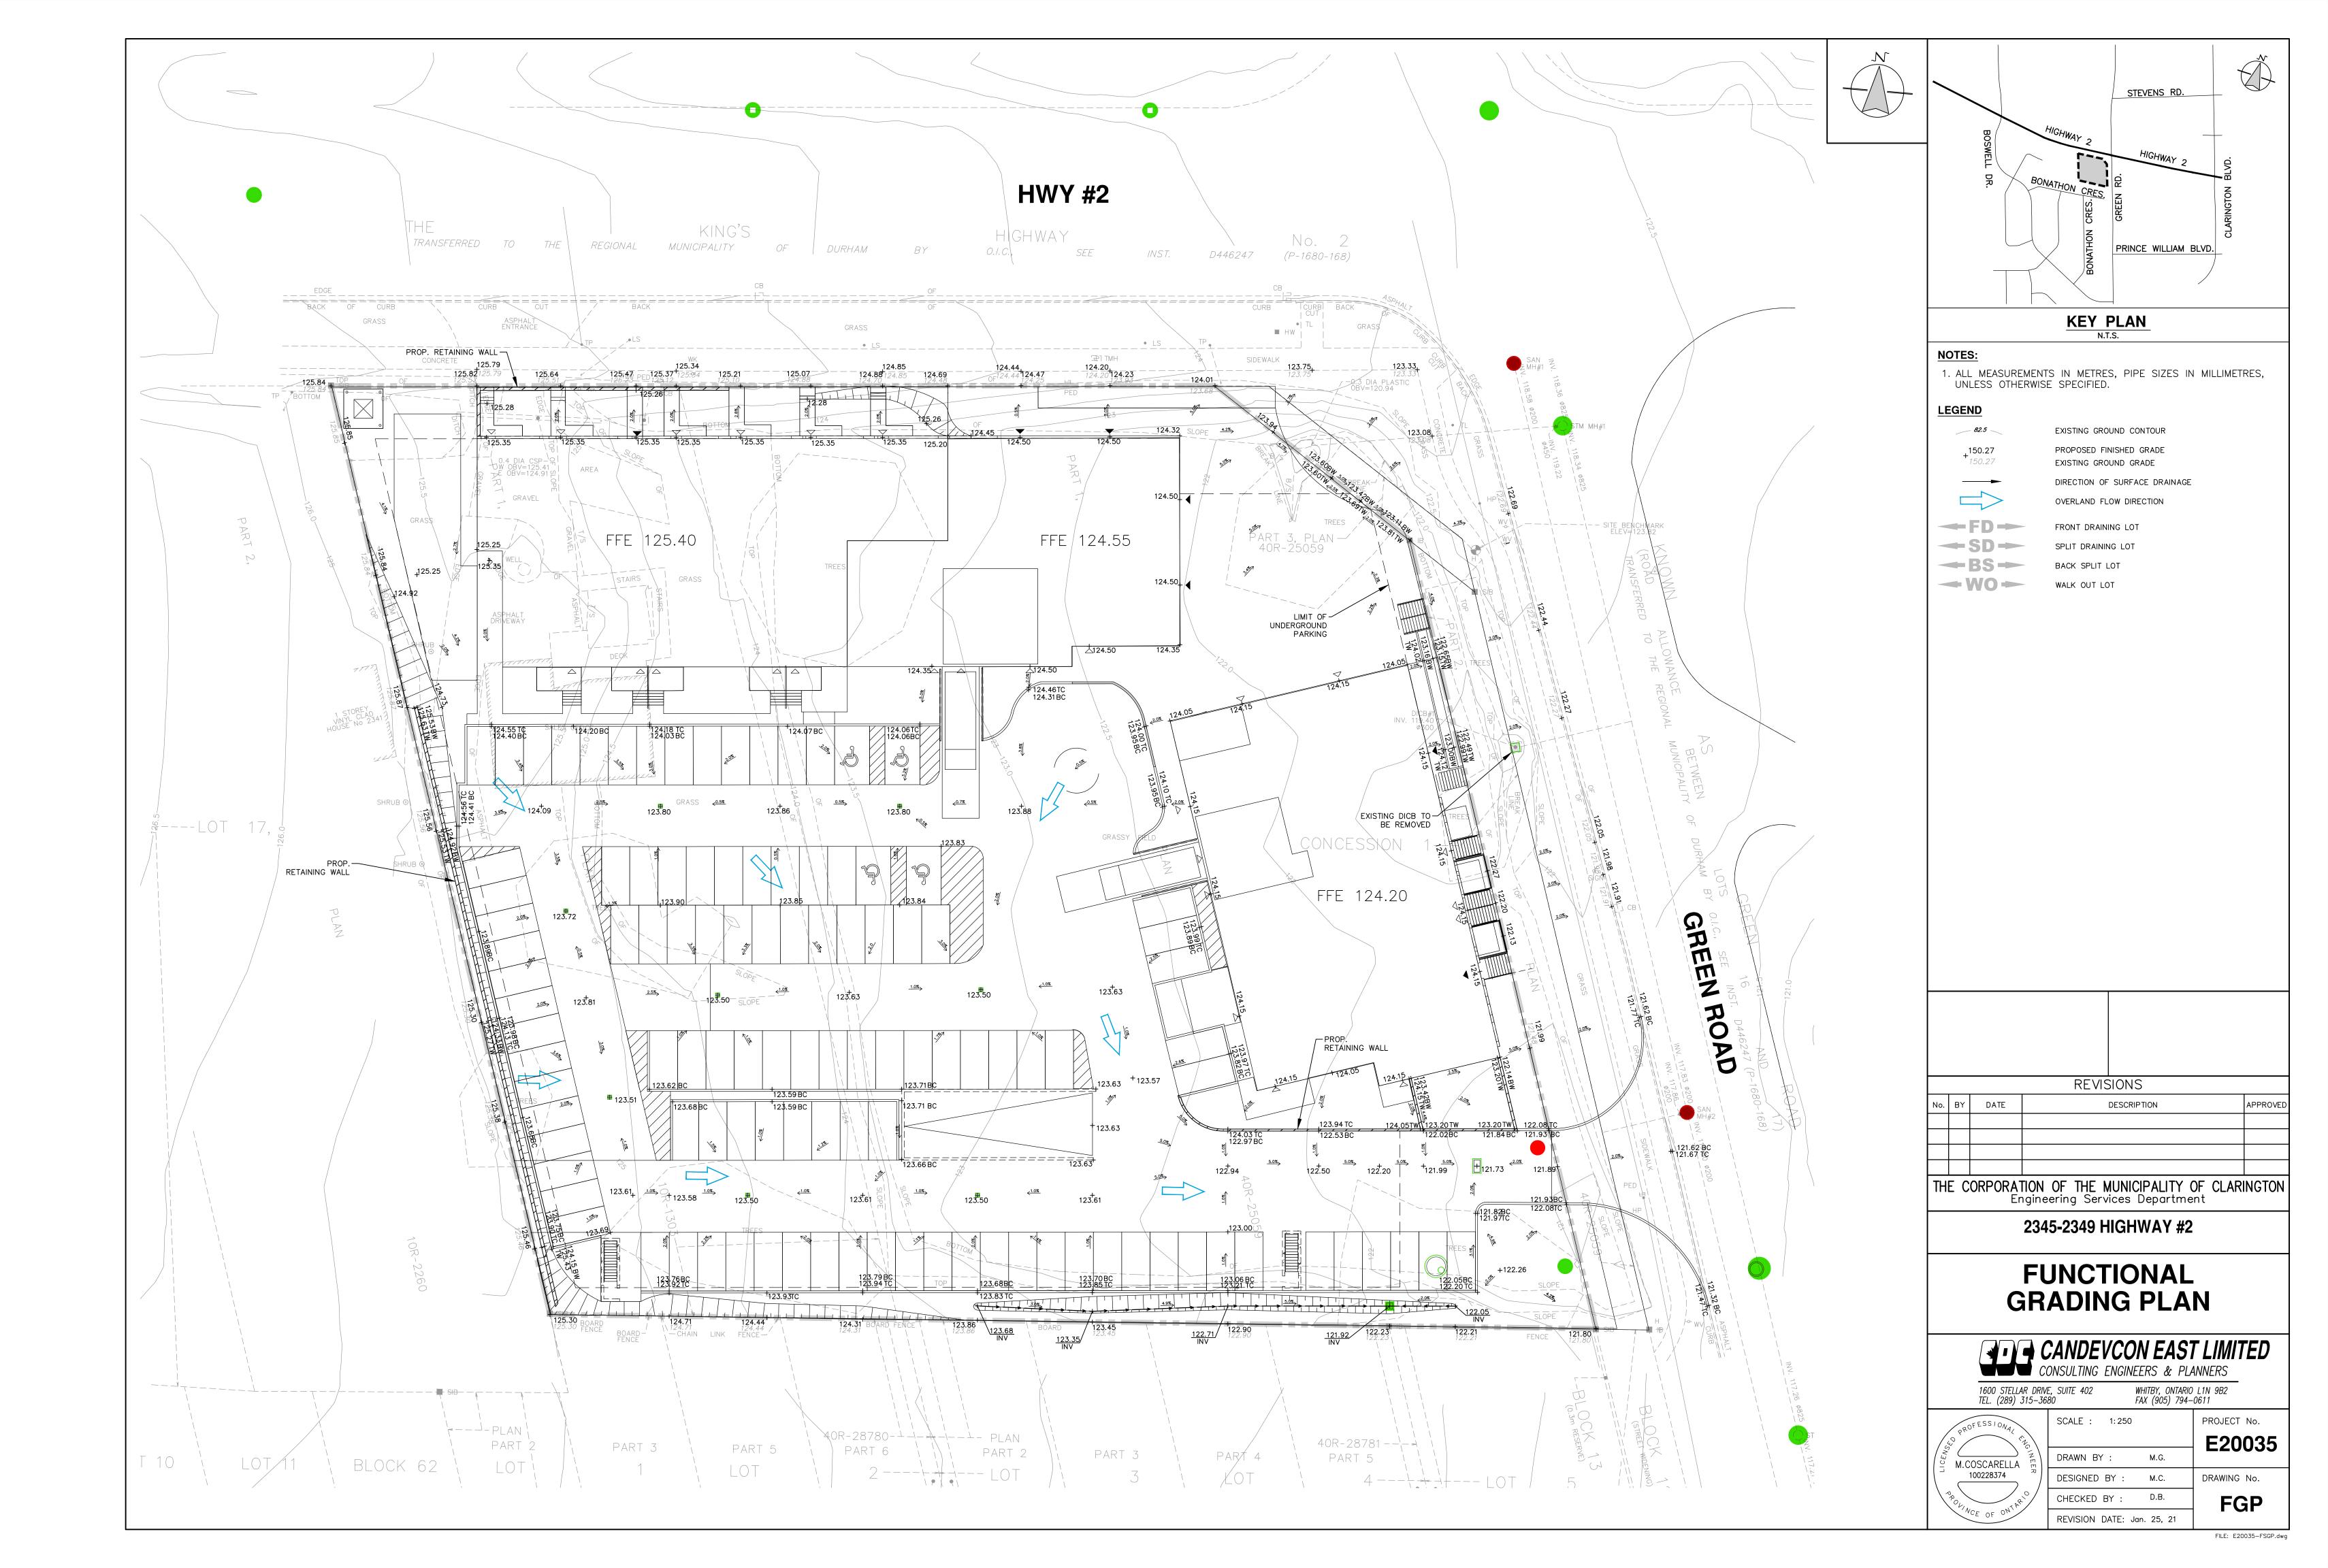


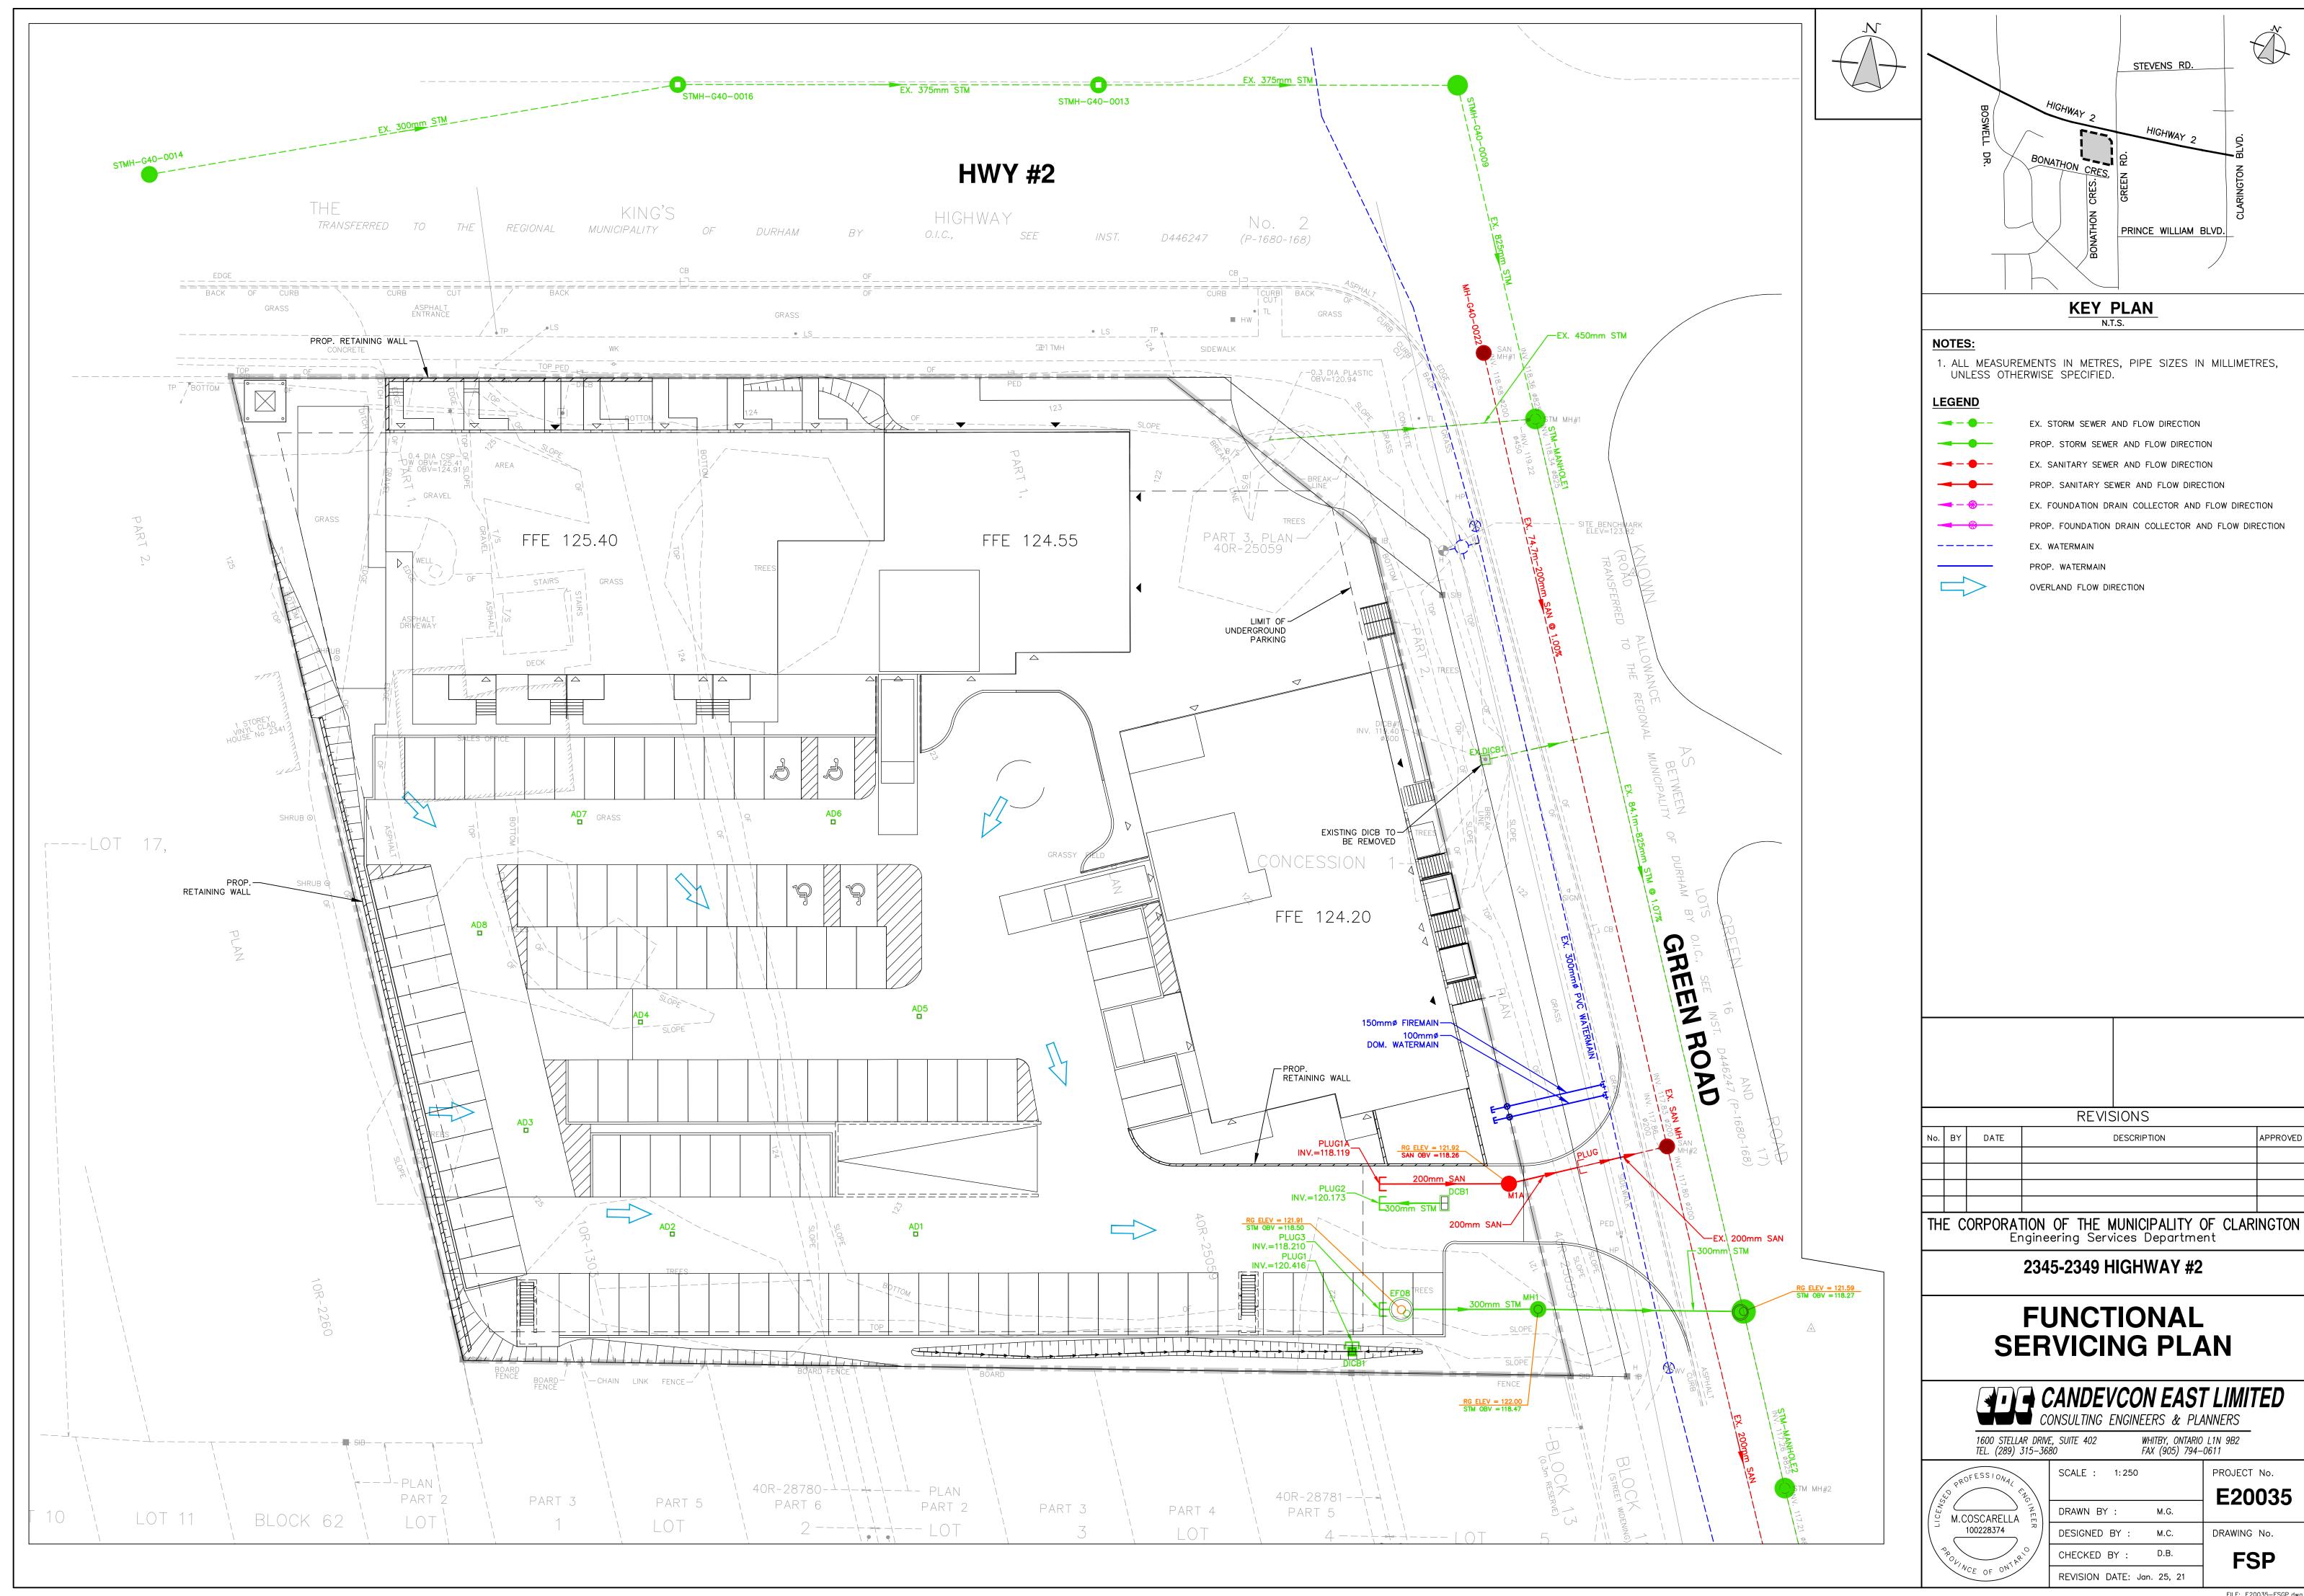

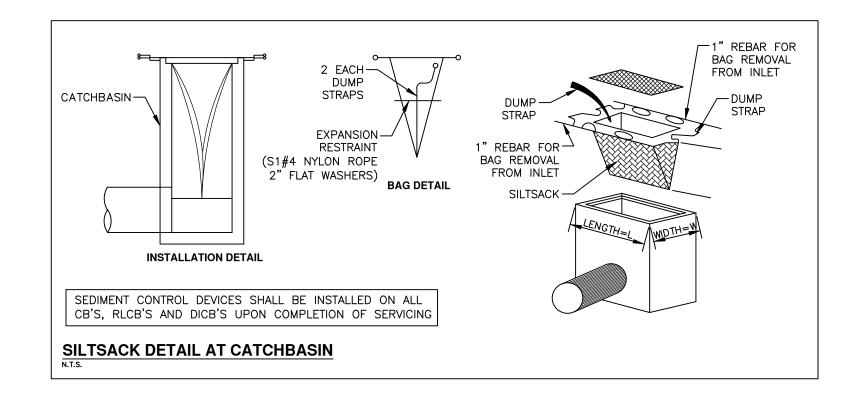

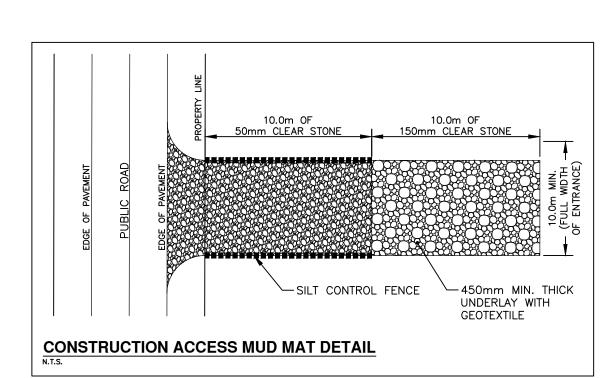

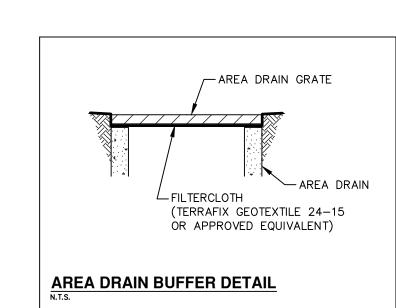

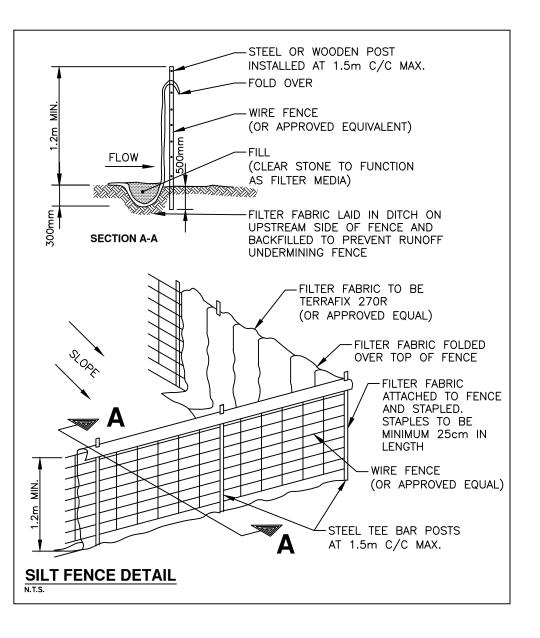



#### **GENERAL EROSION & SEDIMENTATION CONTROL NOTES:**

- 1. NO CONSTRUCTION ACTIVITY OR MACHINERY SHALL INTRUDE BEYOND THE SILT FENCE OR LIMIT OF DEVELOPMENT. ALL CONSTRUCTION VEHICLES SHALL LEAVE THE SITE AT DESIGNATED LOCATION(S) AS SHOWN ON THE PLANS. ALL MATERIALS AND EQUIPMENT SHALL BE STORED ON SITE IN A DESIGNATED AREA. NO MATERIALS OR EQUIPMENT SHALL BE STORED ON
- THE MUNICIPAL RIGHT OF WAY. NO CONSTRUCTION VEHICLES WILL PARK ON MUNICIPAL ROADS. 2. DUST CONTROL TO BE REVIEWED DAILY TO ENSURE DUST IS CONTROLLED AS PER THE TOWN BY-LAWS.

EROSION AND SEDIMENT CONTROL MEASURES DURING CONSTRUCTION, AS DIRECTED BY THE ENGINEER.

- 3. CONTRACTOR TO ADHERE TO TOWN NOISE BY-LAWS.
- 4. SERVICING OF CONSTRUCTION EQUIPMENT ON SITE IS PROHIBITED 5. THE CONTRACTOR SHALL BE RESPONSIBLE FOR THE PROPER INSTALLATION, MAINTENANCE AND REMOVAL OF ALL TEMPORARY
- 6. THE LOCATION OF EROSION AND SEDIMENT CONTROL DETAILS ARE SHOWN SCHEMATICALLY ON THIS DRAWING. 7. ADDITIONAL EROSION AND SEDIMENT CONTROL MEASURES MAY BE REQUIRED AND SHALL BE DETERMINED BY THE ENGINEER.
- 8. ALL SEDIMENT CONTROL MEASURES SHALL BE IN PLACE PRIOR TO COMMENCING ANY CONSTRUCTION ACTIVITIES ON-SITE. 9. ALL CUT-OFF SWALES SHALL BE STABILIZED BEFORE USE, AND SHALL REMAIN IN PLACE AND PROPERLY FUNCTIONING DURING ALL STAGES OF CONSTRUCTION AND SHOULD BE REMOVED ONLY WHEN THE SITE IS COMPLETELY STABILIZED. EXACT LOCATION
- TO BE DETERMINED IN THE FIELD BY THE SITE ENGINEER AND APPROVED BY THE TOWN ENGINEER. 10. TEMPORARY CONSTRUCTION ACCESS ROAD AND MUD MAT TO BE INSTALLED PRIOR TO CONSTRUCTION TO PREVENT MUD
- TRACKING ON ADJACENT EXTERNAL ROADS. 11. SEDIMENT CONTROL DEVICES SHALL BE INSTALLED ON ALL CBs, RLCB's AND DICBs UPON COMPLETION OF SERVICING.
- 12. IF CONSTRUCTION ACTIVITY IS INTERRUPTED AND/OR INACTIVITY EXCEEDS 30 DAYS, ALL STRIPPED/BARE AREAS ARE TO BE STABILIZED WITH SEED/MULCH.
- 13. ALL SEDIMENT CONTROL MEASURES ARE TO BE MAINTAINED IN GOOD REPAIR DURING ALL PHASES OF CONSTRUCTION. ALL DEFICIENCIES ARE TO BE RECTIFIED WITHIN 48 HOURS OF INSPECTION.
- 14. ALL TOPSOIL STOCKPILES SHALL BE SURROUNDED WITH SILT CONTROL FENCE. ALL PILES WHICH ARE STOCKPILED FOR MORE THAN 30 DAYS SHALL BE HYDRO SEEDED.
- 15. ALL EROSION AND SEDIMENTATION CONTROL MEASURES TO REMAIN IN PLACE UNTIL VEGETATION HAS BEEN RE-ESTABLISHED.
- 16. ANY TREES SELECTED BY LANDSCAPE ARCHITECT FOR PRESERVATION TO BE PROTECTED BY TREE PROTECTION FENCING (OPSD 320.010). LANDSCAPE ARCHITECT TO INDICATE ANY TREES THAT ARE TO BE TRANSPLANTED.

17. ADDITIONAL EROSION AND SEDIMENT CONTROL MATERIALS (I.E. SILT FENCES, STRAWBALES, CLEAR STONE ETC.) ARE TO BE

- KEPT ON SITE FOR EMERGENCIES AND REPAIR. 18. CONTRACTOR TO CLEAN ROADS ON A REGULAR BASIS OR AS DIRECTED BY THE ENGINEER. THE ROAD SHALL AT A MINIMUM BE SCRAPED DAILY AND FLUSHED ON FRIDAY EVENING OR SATURDAY MORNING.
- 19. ALL ACTIVITIES, INCLUDING MAINTENANCE PROCEDURES, WILL BE CONTROLLED TO PREVENT THE ENTRY OF PETROLEUM PRODUCTS, DEBRIS, RUBBLE, CONCRETE OR OTHER DELETERIOUS SUBSTANCES IN THE WATER. VEHICULAR REFUELLING AND MAINTENANCE WILL BE CONDUCTED A MINIMUM OF 30m FROM ANY WATERCOURSE.
- 20. AN AFTER HOURS CONTACT NUMBER IS TO BE VISIBLY POSTED ON-SITE FOR EMERGENCIES. ALL CONCERNS SHOULD BE DIRECTED TO: CANDEVCON LIMITED: ROGER BEYNON 289-315-3680 2779471 ONTARIO INC. C/O GAY COMPANY LIMITED: 905-623-3234

#### MONITORING OF SEDIMENT CONTROL MEASURES

- 1. AFTER THE CONTRACTOR HAS INSTALLED THE SEDIMENT CONTROLS, THE CONTRACTOR SHALL NOTIFY THE ENGINEER FOR A REVIEW OF THE INSTALLED MEASURES BEFORE ANY EARTHWORKS CAN
- 2. THE CONTRACTOR SHALL, ON A DAILY BASIS, INSPECT EROSION AND SEDIMENT CONTROL MEASURES IN PLACE. ANY DAMAGED OR INEFFECTIVE MEASURE SHALL BE RECTIFIED WITHIN 48 HOURS.

DAILY DURING EXTENDED RAIN OR SNOWMELT EVENTS.

- 3. DURING EARTHWORKS AND SERVICING OPERATIONS, THE EROSION AND SEDIMENT CONTROL MEASURES SHALL BE INSPECTED ON THE FOLLOWING FREQUENCY: ON A WEEKLY BASIS BEFORE AND AFTER ALL SIGNIFICANT RAINFALL EVENTS. AFTER ALL SIGNIFICANT SNOWMELT EVENTS.
- 4. THE ENGINEER REPRESENTATIVE SHALL REVIEW THE EROSION AND SEDIMENT MEASURES, DAILY, WHEN ON SITE AND SHALL COORDINATE WITH THE ALL PARTIES DURING THEIR WEEKLY REVIEWS. 5. DURING INACTIVE CONSTRUCTION PERIODS (FOR EARTHWORKS AND SERVICING), THE EROSION AND SEDIMENT CONTROL MEASURES SHALL BE INSPECTED ON A MONTHLY SCHEDULE AND BEFORE AND AFTER SIGNIFICANT RAINFALL EVENTS.

#### **DUST CONTROL MEASURES:**

- CONTRACTOR TO ENSURE ALL CONSTRUCTION VEHICLES SHALL LEAVE THE SITE AT DESIGNATED POINTS AND DURING PERIODS OF HIGH WIND LIMIT ENTRY/EGRESS TO THE SITE DURING THESE PERIODS.
- 2. PROPER EROSION CONTROL/WIND FENCING WITH A MINIMUM HEIGHT OF 1.2M IS TO BE INSTALLED ALONG THE PERIMETER OF THE WORK SITE PRIOR TO COMMENCING CONSTRUCTION OPERATIONS. ADDITIONAL WIND FENCING INTERNAL TO THE WORK AREAS WILL BE INSTALLED ON AN AS NEEDED BASIS TO MINIMIZE DUST CIRCULATION, AS DIRECTED BY THE ENGINEER.
- 3. PRIOR TO ANTICIPATED PERIODS OF HIGH WINDS ANY EXPOSED AREAS ARE TO BE INSPECTED BY THE CONTRACTOR AND WATER APPLIED AT SUFFICIENT FREQUENCY AND QUANTITY TO ENSURE SURFACES ARE MOIST TO REDUCE THE RISK DURING
- PERIODS OF HIGH WINDS FOR DUST CIRCULATION. 4. DURING PERIODS OF HIGH WIND, THE CONTRACTOR IS TO MINIMIZE CONSTRUCTION ACTIVITIES UNTIL SUCH TIME WHERE WINDS HAVE DECREASED TO ALLOW FOR LESS DUST TO BE CIRCULATED.
- 5. SUITABLE CHEMICAL STABILIZATION METHODS THAT MAY INCLUDE SODIUM CHLORIDE SOLUTIONS, OIL BASED BRINE SOLUTIONS, OR CANOLA OIL BASED SOLUTIONS MAY BE APPLIED BY THE CONTRACTOR IN CONSULTATION WITH THE
- 6. ANY CHEMICAL STABILIZATION METHODS EMPLOYED BY THE CONTRACTOR MUST CONFORM TO THE MINISTRY OF ENVIRONMENT AND CLIMATE CHANGE POLICIES WITH REGARDS TO CONTROLLED SUBSTANCES AND UTILIZED AS PER

#### CONSTRUCTION STAGING & REQUIRED MEASURES

SILT/SNOW FENCE MUD MAT

MANUFACTURERS RECOMMENDATIONS.

- TOPSOIL & MIXED MATERIAL REMOVAL SILT/SNOW FENCE
- MUD MAT - CATCHBASIN BUFFER/SILTSACK EARTHWORKS & FILL IMPORT
- SILT/SNOW FENCE MUD MAT

CLEARING AND GRUBBING


- CATCHBASIN BUFFER/SILTSACK UNDERGROUND SERVICING & ROADWORKS SILT/SNOW FENCE
- MUD MAT - CATCHBASIN BUFFER/SILTSACK BUILDING CONSTRUCTION
- SILT/SNOW FENCE MUD MAT - CATCHBASIN BUFFER/SILTSACK
- BUILDING COMPLETION - DECOMMISSION ALL SEDIMENT CONTROL MEASURES - RESTORE ALL DISTURBED AREAS

## DRY MEADOW SEED MIX

- APPLY THE FOLLOWING SEED MIX AT A MINIMUM RATE OF 15kg/Ha, SIMULTANEOUSLY SOWING A COVER CROP OF ANNUAL OATS FOR EROSION CONTROL (RATE OF 30 kg/Ha) 20% FOWL MEADOW GRASS (POA PALUSTRIS)
- 15% LITTLE BLUESTEM (ANDROPOGON SCOPARIUS) 15% INDIANGRASS (SORGHASTRUM NUTANS) 15% VIRGINIA WILD RYE (ELYMUS VIRGINICUS) • 10% SIDEOATS GRAMMA (BOUTELOUA CURTIPENDULA)
- 4% WHITE ASTER (ASTER UMBELLATÚS) 4% BUTTERFLY MILKWEED (ASCLEPIAS TUBEROSA)
- 3% HEATH ASTER (ASTER PILOSUS) • 3% BLACK EYED SUSAN (RUDBECKIA HIRTA)

5% WILD LUPINE (LUPINUS PERENNIS)

2% SHOWY TICK-TREFOIL (DESMODIUM CANADENSE)

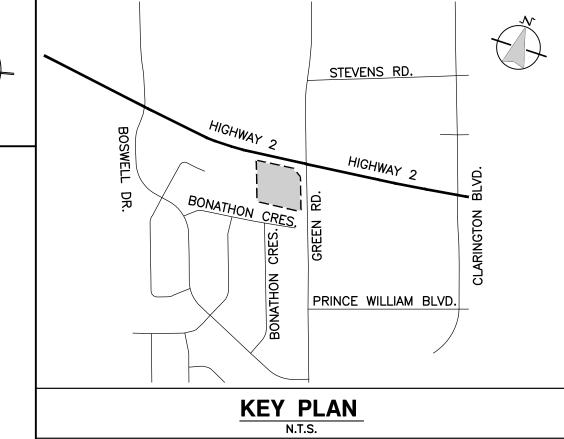

1. ALL MEASUREMENTS IN METRES, PIPE SIZES IN MILLIMETRES, UNLESS OTHERWISE SPECIFIED.

\_ *82.5* \_ EXISTING GROUND CONTOUR 

STRAW BALE REINFORCED DOUBLE SILT FENCE

TEMPORARY SWALE

CONSTRUCTION ACCESS MUD MAT

ROCK FLOW CHECK DAM

SWALE INVERT


CATCHBASIN BUFFER / SILTSACK RISER PIPE LOT DRAIN

OVERLAND FLOW DIRECTION


REVISIONS No. BY DATE DESCRIPTION


## THE CORPORATION OF THE MUNICIPALITY OF CLARINGTON Engineering Services Department 2345-2349 HIGHWAY #2

**EROSION & SEDIMENTATION CONTROL PLAN** 

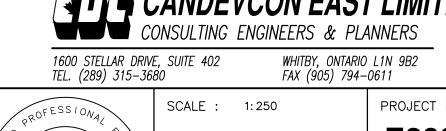

PROJECT No. E20035 DRAWN BY: M.G. M.COSCARELLA 100228374 DESIGNED BY: M.C. DRAWING No. CHECKED BY : D.B. REVISION DATE: Jan. 25, 21

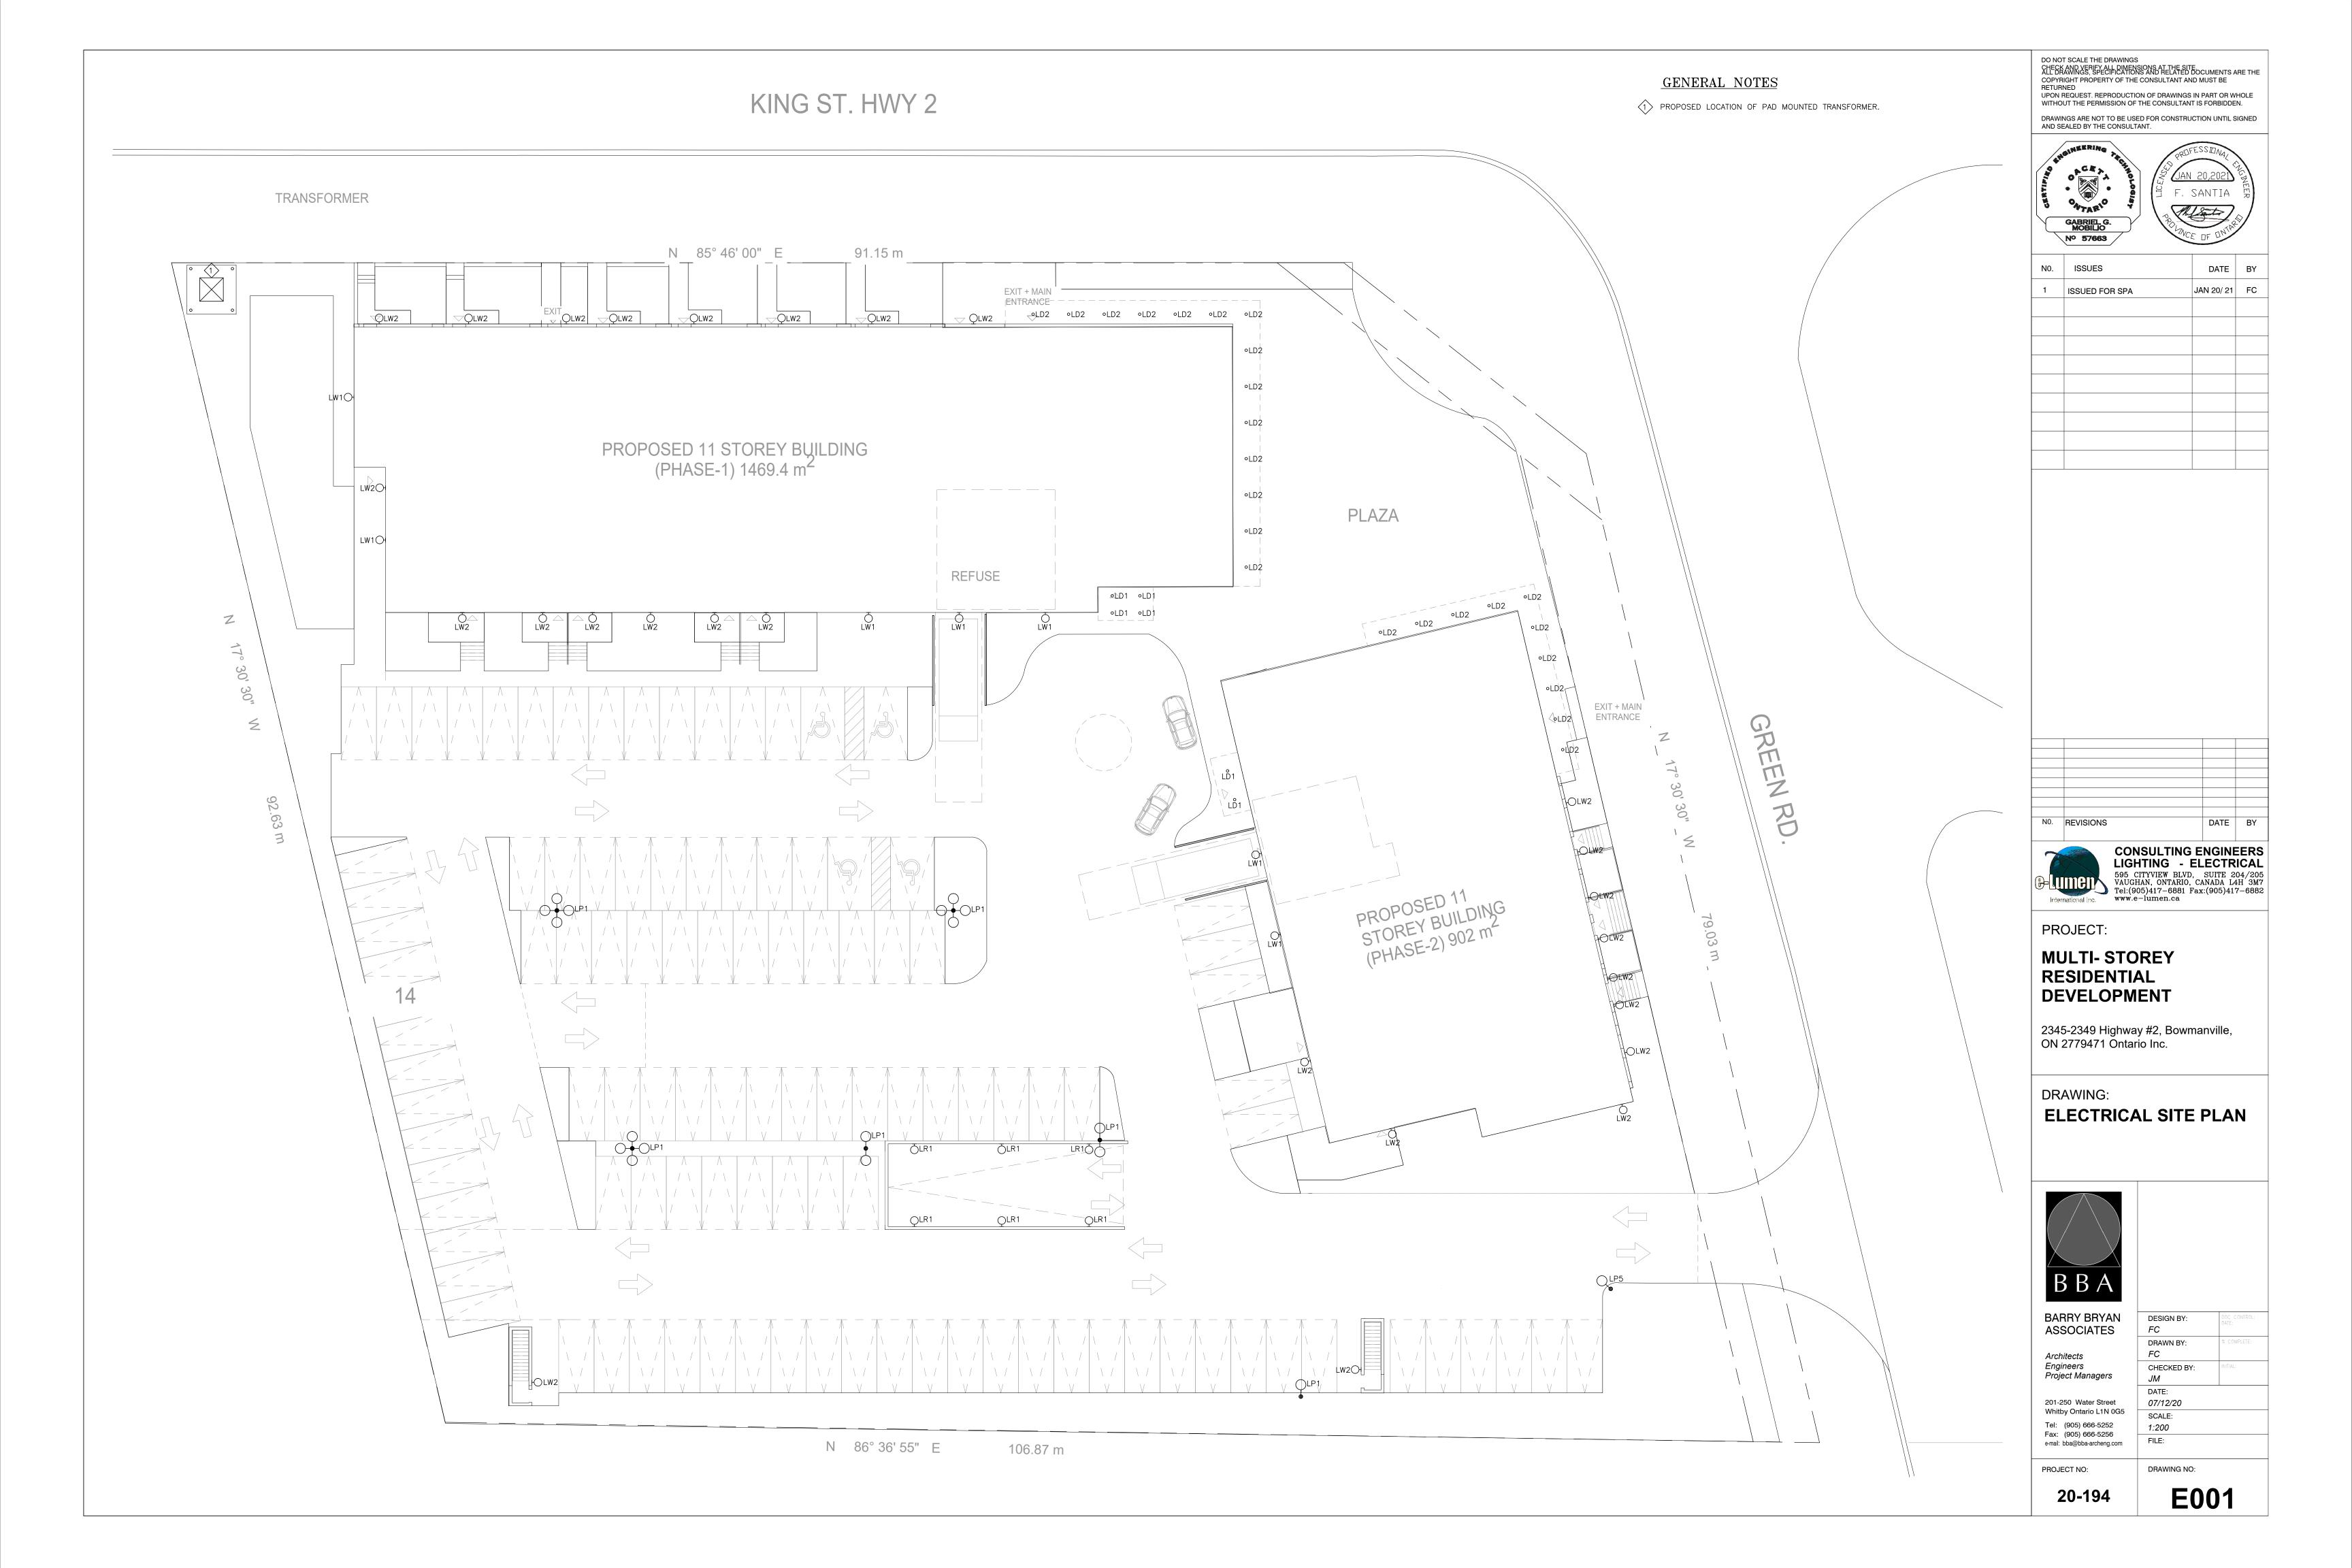

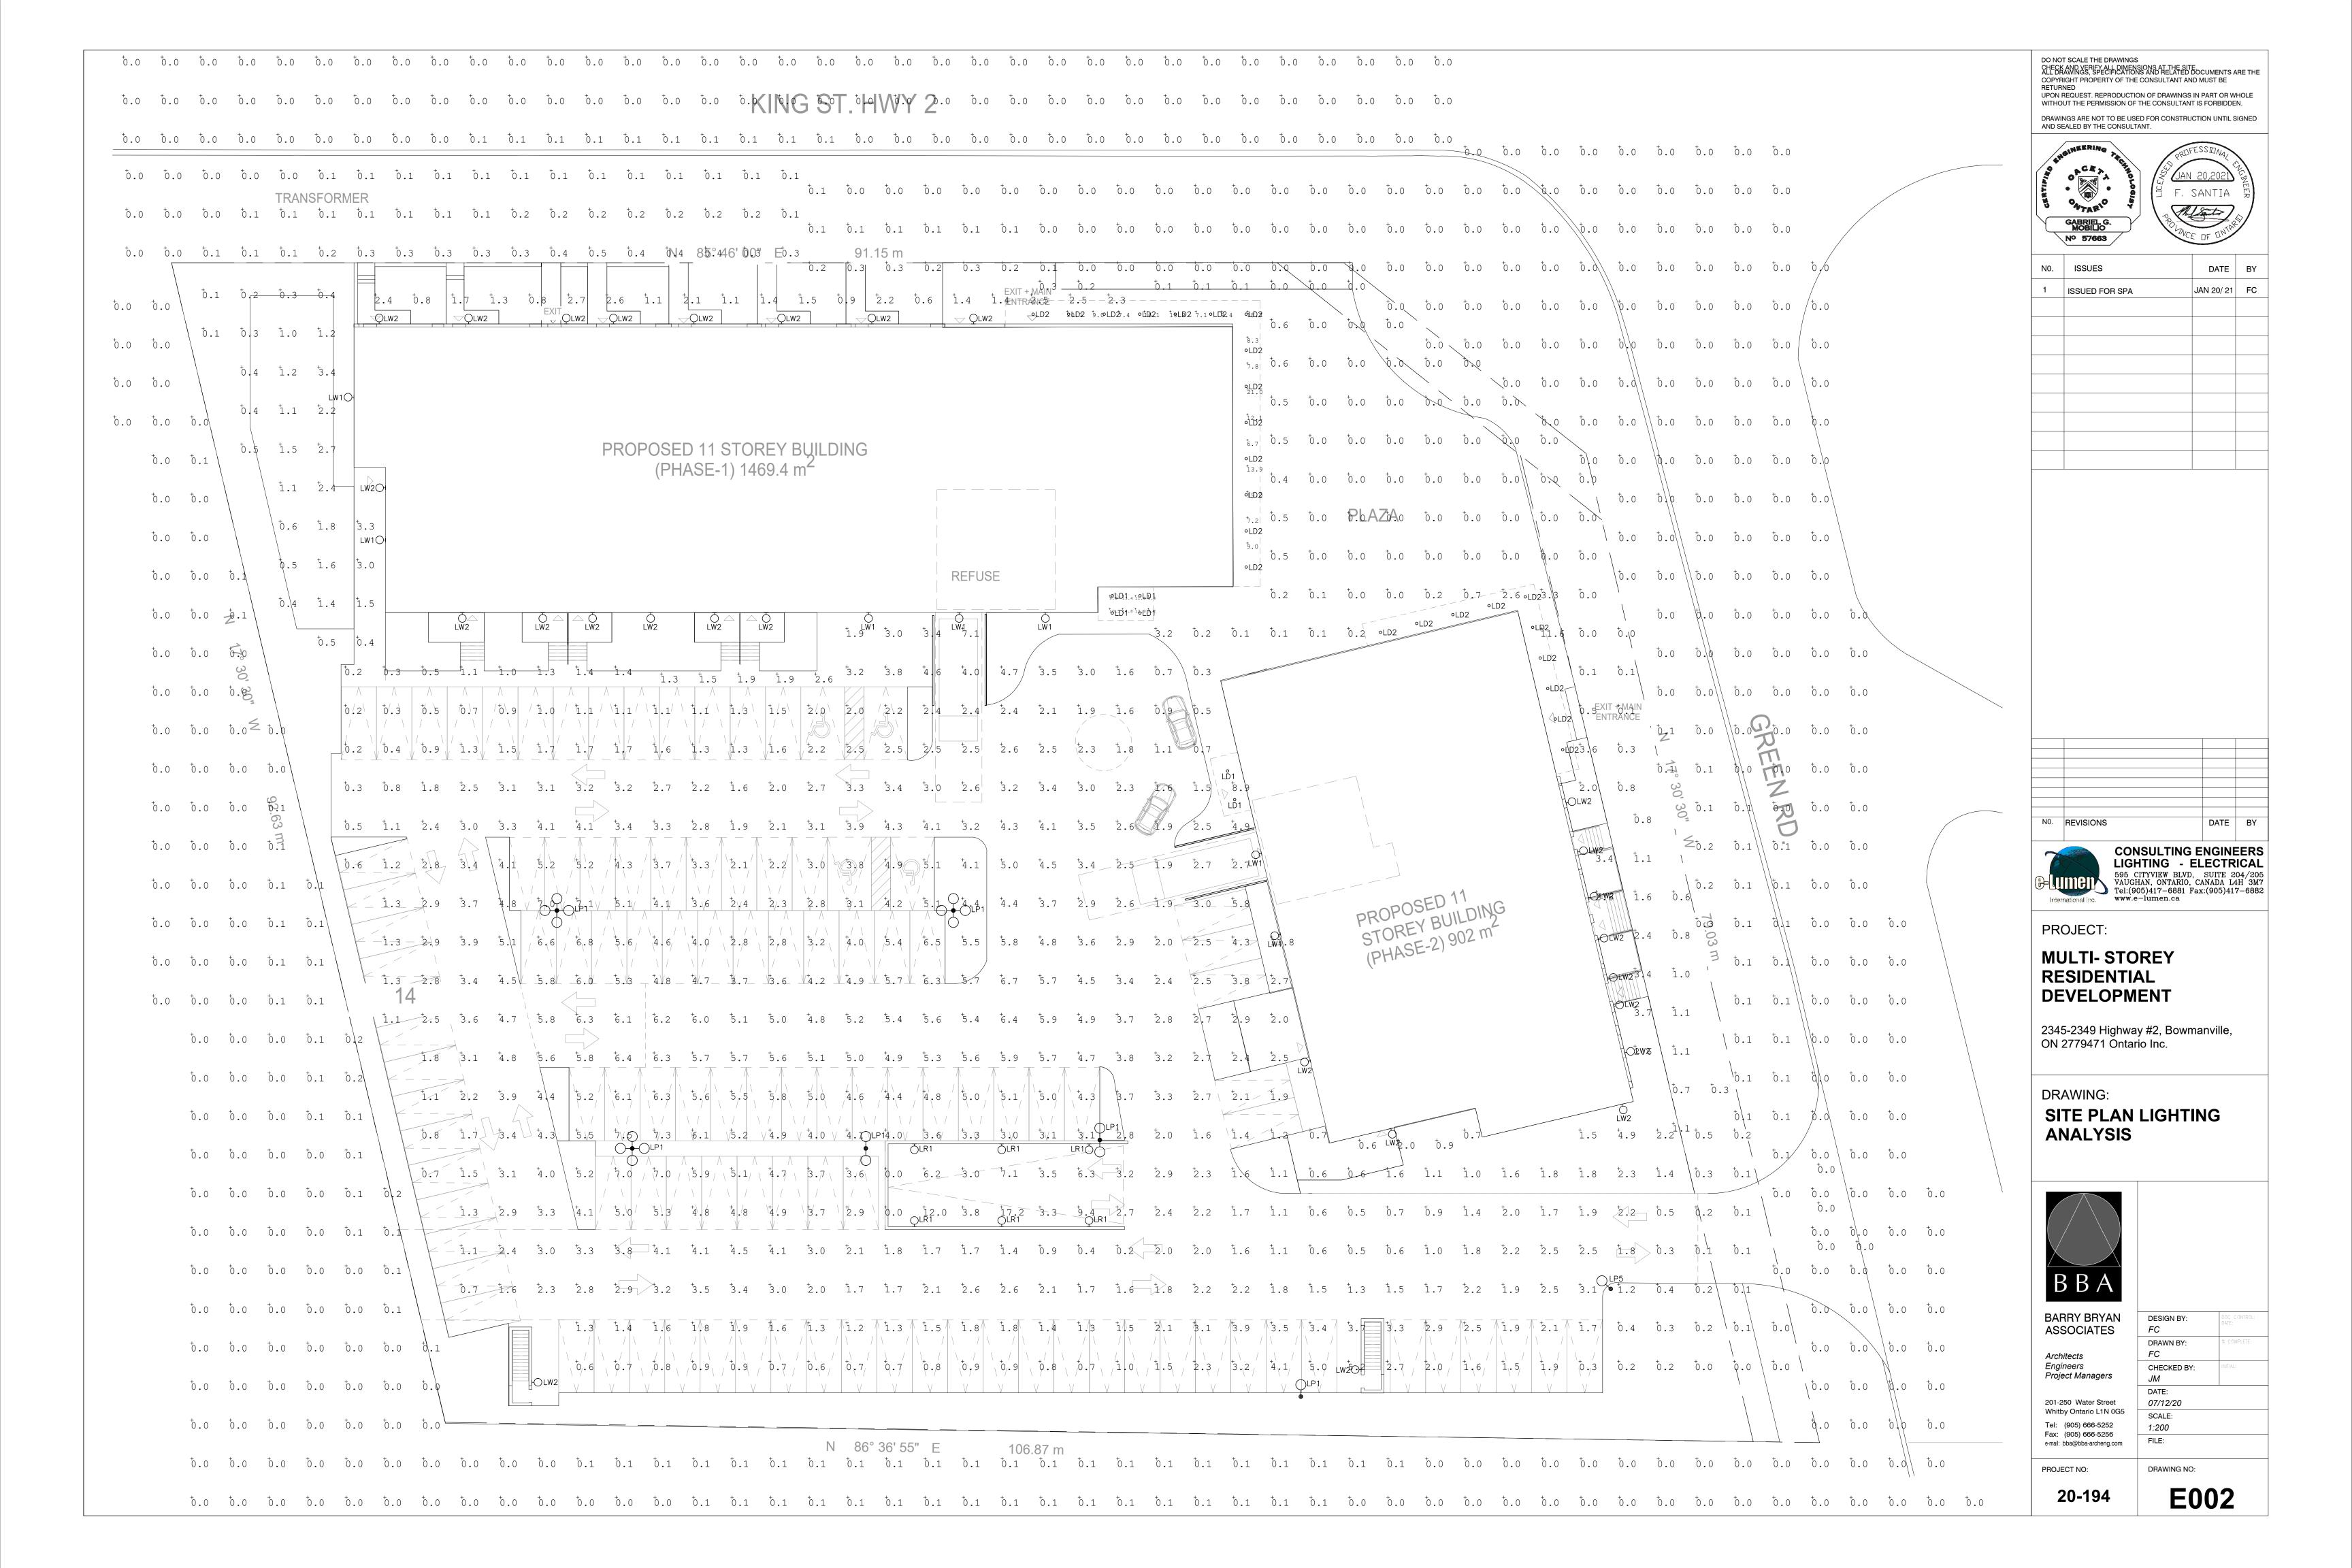

#### LUMINAIRE SCHEDULE SYMBOL LABEL ARRANGEMENT TOTAL LAMP LUMEN | LLF | MOUNTING HEIGHT MANUFACTURER EQUAL MANUFACTURER KIM LIGHTING: LITHONIA LIGHTING - DSX0 SINGLE 5813 0.9 5640mm $\bigcirc$ CAT# ALT1-28L-85-4K7-2-BC VISIONAIRE LIGHTING - VLX KIM LIGHTING: LITHONIA LIGHTING - DSX0 LP2 2 @ 180DEG 9610(EACH) 5640mm CAT# ALT1-28L-85-4K7-4W VISIONAIRE LIGHTING - VLX LITHONIA LIGHTING — DSXO LP3 4 @ 90DEG 0.9 7317(EACH) 5640mm CAT# ALT1-28L-85-4K7-4W VISIONAIRE LIGHTING - VLX KIM LIGHTING: LITHONIA LIGHTING - DSX0 LP4 4 @ 90DEG 9610(EACH) 0.9 5640mm $\bigcirc \downarrow \bigcirc$ CAT# ALT1-28L-60-4K7-4 VISIONAIRE LIGHTING - VLX KIM LIGHTING: LITHONIA LIGHTING - DSX0 7317 0.9 LP5 SINGLE 5640mm $\bigcirc$ CAT# ALT1-28L-60-4K7-4-BC VISIONAIRE LIGHTING - VLX LITHONIA LIGHTING — WDGE LW1 SINGLE 2789 0.9 3000mm CAT# TRP1-12L30-4K7-4 VISIONAIRE LIGHTING - PGAS-1 LUMINAIRE LED - SONAR SPC8 LW2 SINGLE 1379 0.9 1800mm CAT# GRDW24-L18.0-TE500--40K VISA LIGHTING - OW1043 KIM LIGHTING: REBELLE ARCH LIGHTING - 1185LED SINGLE 734 0.9 762mm CAT# LLF50P40-12L4K WEEF LIGHTING - 6162320 LITHONIA LIGHTING - LDN4 0.9 2700mm SINGLE CAT# LTR-4RD-H-SL-06L-DM1 $\circ$ C/W LTR-4RD-T-SL-40K-8-NR-S ELITE - HH4 LED LITHONIA LIGHTING - LDN4 LD2 SINGLE 0.9 3000mm CAT# LTR-4RD-H-SL-06L-DM1 $\circ$ ELITE - HH4 LED C/W LTR-4RD-T-SL-40K-8-NR-S

CALCULATION SUMMAR	Y						
LABEL	CALCTYPE	UNITS	AVG	MAX	MIN	AVG/MIN	MAX/MIN
HANDICAP	ILLUMINANCE	Fc	2.72	3.7	2.0	1.36	1.85
TYPE LW2	ILLUMINANCE	Fc	1.67	2.7	0.6	2.78	4.5
PARKING LOT	ILLUMINANCE	Fc	3.05	6.8	0.2	15.25	34.0
SITE	ILLUMINANCE	Fc	2.57	17.2	0.0	N/A	N/A
SPILL OF LIGHT	ILLUMINANCE	Fc	0.02	0.3	0.0	N/A	N/A
TYPE LD1	ILLUMINANCE	Fc	11.33	14.8	8.4	1.35	1.76
TYPE LD2	ILLUMINANCE	Fc	12.17	20.2	1.4	8.69	14.43
TYPE LR1	ILLUMINANCE	Fc	8.80	13.7	2.8	3.14	4.89
TYPE LW1	ILLUMINANCE	Fc	5.12	10.2	3.2	1.60	3.19

## LIGHTING POLE BASE DETAIL

SURFACE MOUNTED @PARKING CEILING

NOTES:

GROUND LUG IN LIGHT

FROM HANDHOLE -

#2/0 BARE STRANDED

COPPER DOWN-

PROVIDE ONE ELECTRICAL

GROUND ELECTRODE 19mm

ON EACH HOME RUN POLE BEFORE ENTRY INTO BUILDING. COORDINATE WITH ELECTRICAL

CONTRACTOR ON SITE FOR

INCOMING CONDUIT

THE EXACT POLES.

DIAMETER X 3000mm LONG

STANDARD TO BE ACCESSIBLE

#2/0 BARE STRANDED

CONCRETE

609.6mm (24") DIA SONOTUBE

6#15M DOWELS

8#10M AT

TO OTHER FIXTURES

1. PROVIDE ALL WORK ASSOCIATED WITH THIS DETAIL. FINISH TO SUIT ARCHITECT'S REQUIREMENTS.

EXACT LOCATION OF POLE MOUNTED LUMINAIRES TO

BE COORDINATED WITH ARCHITECTURAL SITE PLAN.

16 IN ACCORDANCE WITH DETAILS OF DIVISION 3.

3. ELECTRICAL CONTRACTOR TO SIZE CONDUIT/FEEDER TO SUIT.

4. CAST-IN-PLACE ARCHITECTURAL CONCRETE BASE SHALL BE

4" (103MM) SQUARE LIGHTING POLE,

—SEE`SPECIFICATIONS FOR DETAILS

ANCHOR BOLTS (TOTAL OF 4)

MCOMING & OUTGOING CONDUIT

CONCRETE CEILING OF

UNDERGROUND PARKING

SURFACE MOUNTED @PARKING CEILING

AS REQUIRED. SEE NOTE. 3.

OUTGOING CONDUIT

----BASE COVER

762mm (2'-6")

FINISHED GRADE

10M TIES @304

2. REFER TO STRUCTURAL DRAWINGS FOR DETAILS OF BASE. THE BASE SHALL BE PROVIDED BY DIVISION

REFER TO SITE PLAN FOR DETAILS.

ARTFORM 'KELLAMY' 610R STYLE.








LUMINAIRE - TYPE LW1

NOTES: INSTALL BOLTS ACCURATELY CENTERED WITHIN 1/16" OF NOMINAL POSITION FOR PROPER FIT WITH BASE. -INSTALL SERVICE CONDUIT AT 203.2mm BOLT -CENTER OF BASE SQUARE BASE PATTERN BOLT-ON LUMINAIRE MOUNTING ORIENTATION AS SHOWN LUMINAIRE (SA Q90 SHOWN)

ANCHOR BOLTS DETAIL

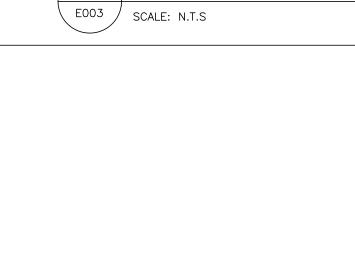



9	LUMINAIRE	_	TYPE	LW2	
E003 /	SCALE: N.T.S				

CHECK AND VERIFY ALL DIMENSIONS AT THE SITE.
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DO NOT SCALE THE DRAWINGS



N0.	ISSUES	DATE
1	ISSUED FOR SPA	JAN 20/ 21

N0.	REVISIONS		DATE	BY
	CONSULTING ENGINEERS			



PROJECT:

#### **MULTI- STOREY** RESIDENTIAL **DEVELOPMENT**

2345-2349 Highway #2, Bowmanville, ON 2779471 Ontario Inc.

DRAWING:

SITE PLAN DETAILS



BBA	
BARRY BRYAN ASSOCIATES	DESIGN BY:  FC  DOC ODATE:
Architects	DRAWN BY: % COI
Engineers Project Managers	CHECKED BY: INITIAL:
201-250 Water Street	DATE: 07/12/20
Whitby Ontario L1N 0G5 Tel: (905) 666-5252 Fax: (905) 666-5256	SCALE: 1:200
e-mail: bba@bba-archeng.com	FILE:
ROJECT NO:	DRAWING NO:

20-194 **E003** 


#### 1 LUMINAIRE SCHEDULE & STATISTICS E003 / SCALE: N.T.S

NOTES:

POLE DETAIL

E003 | SCALE: N.T.S

1. PROVIDE 4" (103MM) SQUARE POLE TO SUIT.

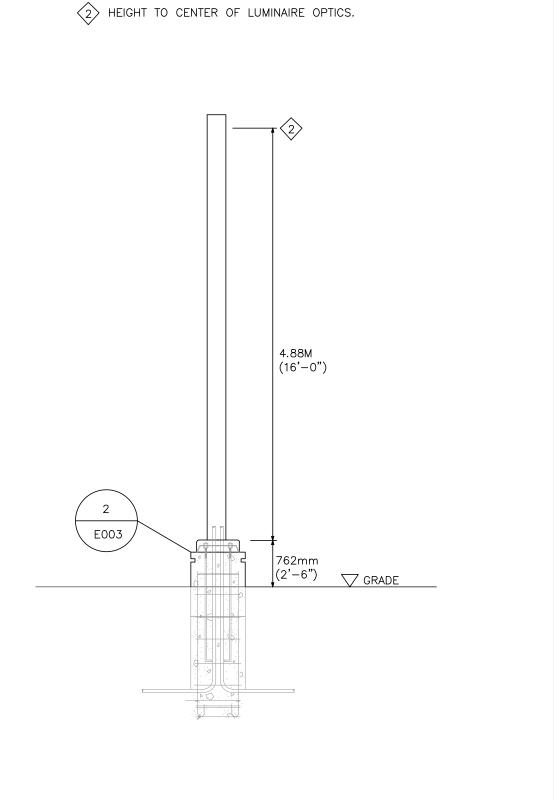

5 LUMINAIRE - TYPE LD1/LD2 E003 SCALE: N.T.S





LUMINAIRE - TYPE LR1 E003 SCALE: N.T.S



E003 / SCALE: N.T.S




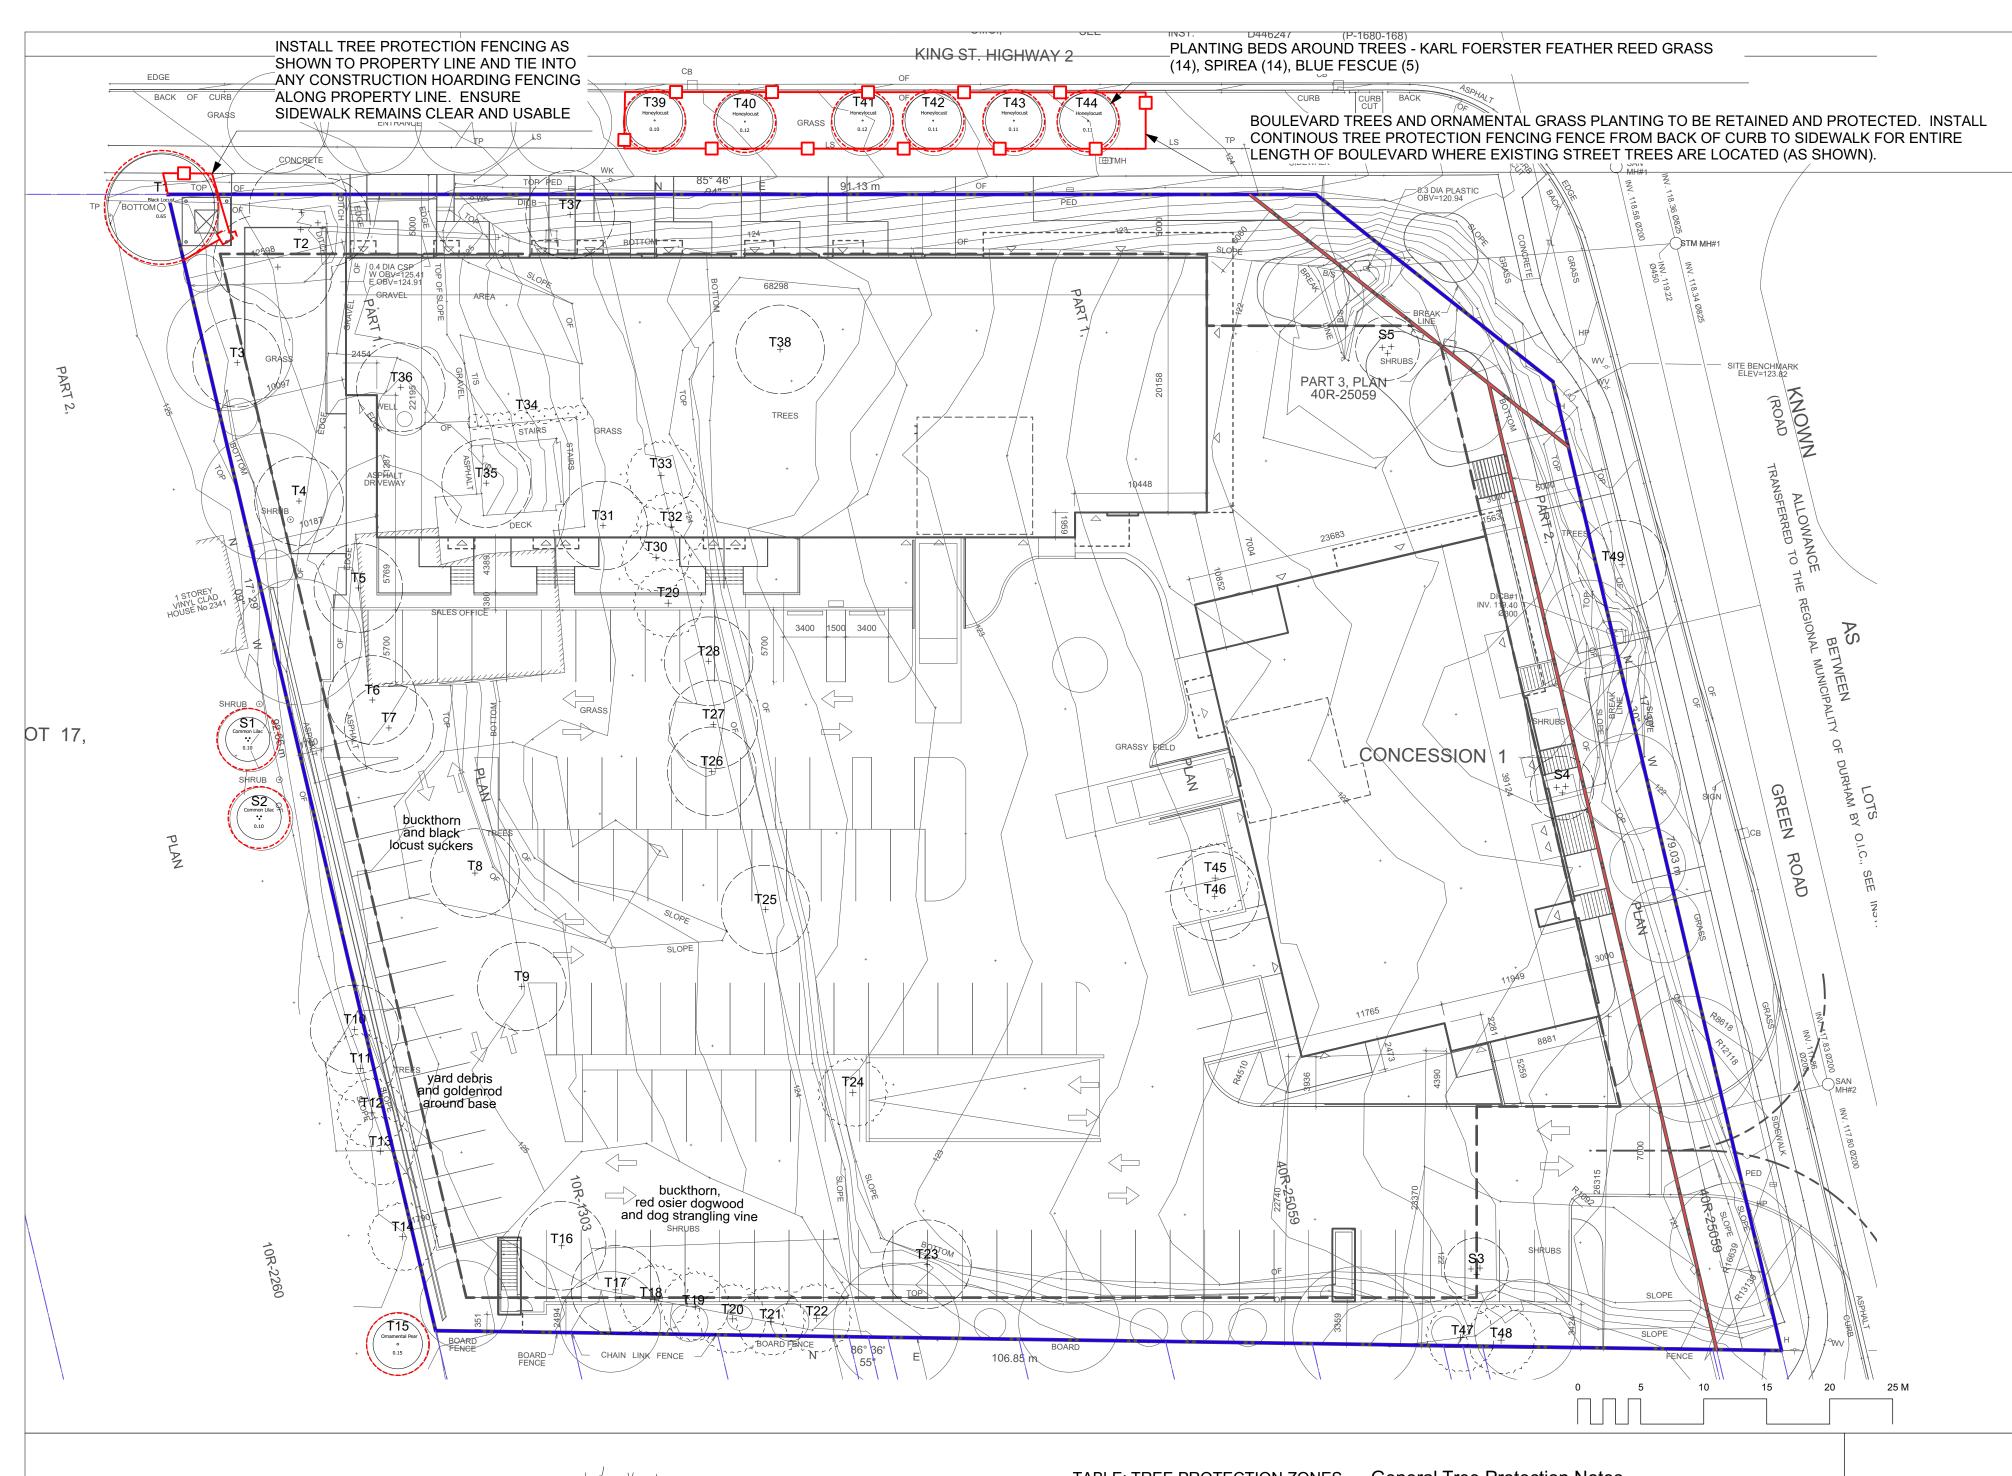

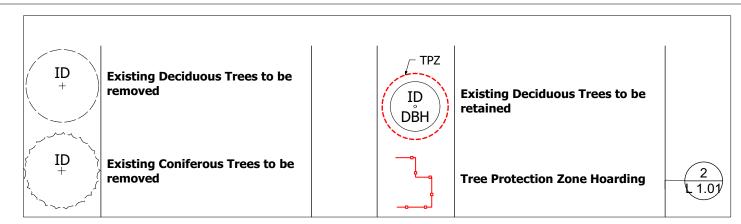

Tree No.	Species	Size	Condition	Action
T1	black locust (Robinia pseudoacacia)	65cm DBH	Fair-Poor	Preserve
T2	black locust (Robinia pseudoacacia)	6 stems 7-25cm DBH	Fair	Remove
T3	black locust (Robinia pseudoacacia)	2 stems 18cm DBH	Fair-Poor	Remove
T4	Siberian elm (Ulmus pumila)	suckers		Remove
T5	siberian elm & black locust	suckers along foundation		Remove
T6	siberian elm & black locust	suckers along foundation		Remove
T7	black locust (Robinia pseudoacacia)	2 stems 25cm DBH		Remove
T8	green ash (Fraxinus pennsylvanica)	2 stems 37/40cm DBH	Poor	Remove
T9	black locust (Robinia pseudoacacia)	2 stems 10/12cm DBH	Fair	Remove
T10	Siberian elm (Ulmus pumila)		Fair	
T11		2 stems 15cm DBH		Remove
	Austrian pine (Pinus nigra)	19cm DBH	Fair-Good	Remove
T12	Austrian pine (Pinus nigra)	20cm DBH	Fair-Good	Remove
T13	Austrian pine (Pinus nigra)	21cm DBH	Fair-Good	Remove
T14	Austrian pine (Pinus nigra)	24cm DBH	Fair-Good	Remove
T15	ornamental pear (Pyrus ssp.)	15cm DBH	Fair	Preserve - adjacent property
T16	Siberian elm (Ulmus pumila)	2 stems 40/45cm DBH	Poor	Remove
T17	apple (Malus ssp.)	25cm DBH	Fair	Remove
T18	Scots pine (Pinus sylvestris)	21cm DBH	Fair	Remove
T19	Scots pine (Pinus sylvestris)	16cm DBH	Fair	Remove
T20	Scots pine (Pinus sylvestris)	11cm DBH	Fair	Remove
T21	Scots pine (Pinus sylvestris)	18cm DBH	Fair	Remove
T22	Scots pine (Pinus sylvestris)	21cm DBH	Fair	Remove
T23	weeping willow (Salix babylonica)	3 stems 15/19/18cm DBH	Good-Fair	Remove
T24	Scots pine (Pinus sylvestris)	8cm DBH	Good	Remove
T25	green ash (Fraxinus pennsylvanica)	13cm DBH	Fair	Remove
T26	Norway maple (Acer platanoides)	52cm dia. at 1m ht	Fair	Remove
T27	Norway maple (Acer platanoides)	2 at 0.6m ht 20/22cm DBH	Fair	Remove
T28			Fair	Remove
	Norway maple (Acer platanoides)	54cm dia. at 0.6m ht		
T29	Norway spruce (Picea abies)	25cm DBH	Good	Remove
T30	Norway spruce (Picea abies)	24cm DBH	Good	Remove
T31	ornamental pear (Pyrus ssp.)	6 suckers 10cm DBH	Fair	Remove
T32	Scots pine (Pinus sylvestris)	25cm DBH	Fair	Remove
T33	Scots pine (Pinus sylvestris)	25cm DBH	Fair	Remove
T34	pyramidal cedar (Thuja occidentalis ssp.)	row of 10 @ 5-10cm DBH	Fair	Remove
T35	Norway maple (Acer platanoides)	2 stems 30cm DBH	Fair	Remove
T36	black locust (Robinia pseudoacacia)	15-25cm DBH suckers		Remove
T37	black locust (Robinia pseudoacacia)	10-15cm DBH suckers		Remove
T38	black locust (Robinia pseudoacacia)	stand of suckers 10-15cm DBH		Remove
T39	honeylocust (Gleditsia triacanthos)	10cm DBH	Good	Preserve
T40	honeylocust (Gleditsia triacanthos)	12cm DBH	Good	Preserve
T41	honeylocust (Gleditsia triacanthos)	12cm DBH	Good	Preserve
T42	honeylocust (Gleditsia triacanthos)	11cm DBH	Good	Preserve
T43			Good	
	honeylocust (Gladitaia triacanthos)	11cm DBH		Preserve
T44 T45	honeylocust (Gleditsia triacanthos)	11cm DBH	Good	Preserve
T45	Scots pine (Pinus sylvestris)	12 at 10cm DBH	Good	Remove
T46	trembling aspen (Populus tremuloides)	20 at 5-10cm DBH	Good	Remove
T47	eastern white cedar (Thuja occidentalis)	10cm DBH	Good	Remove
T48	eastern white cedar (Thuja occidentalis)	10cm DBH	Good	Remove
T49	Siberian elm (Ulmus pumila)	5 stems at base 10-14cm DBH	Fair	Remove
Shrub No.				
S1	common lilac (Syringa vulgaris)	multi-stem 5-10cm DBH		Preserve - adjacent property
S2	1 1 1 1 1 1			
	common lilac (Syringa vulgaris)	multi-stem 5-10cm DBH		Preserve - adjacent property
S3	willow, red osier dogwood, sea buckthorn	4m height		Remove
S4	willow, elderberry, common lilac	5m height		Remove

TREE SPECIES	CALIPER (cm)	QUANTITY	% BY GENUS
Northern Red Oak	6	5	12%
Eastern White Pine	250cm ht	2	17%
Firefall Maple	6	5	12%
Emerald City Tulip Tree	7	2	5%
Shademaster locust	6	2	5%
Columnar Eastern White Pine	250cm ht	5	17%
Eastern Arborvitae	250cm ht	5	12%
Hackberry	6	3	7%
Spring Flurry Serviceberry	6	2	10%
Black Tulip Magnolia	175cm ht	3	7%
Exclamation Planetree	8	2	5%

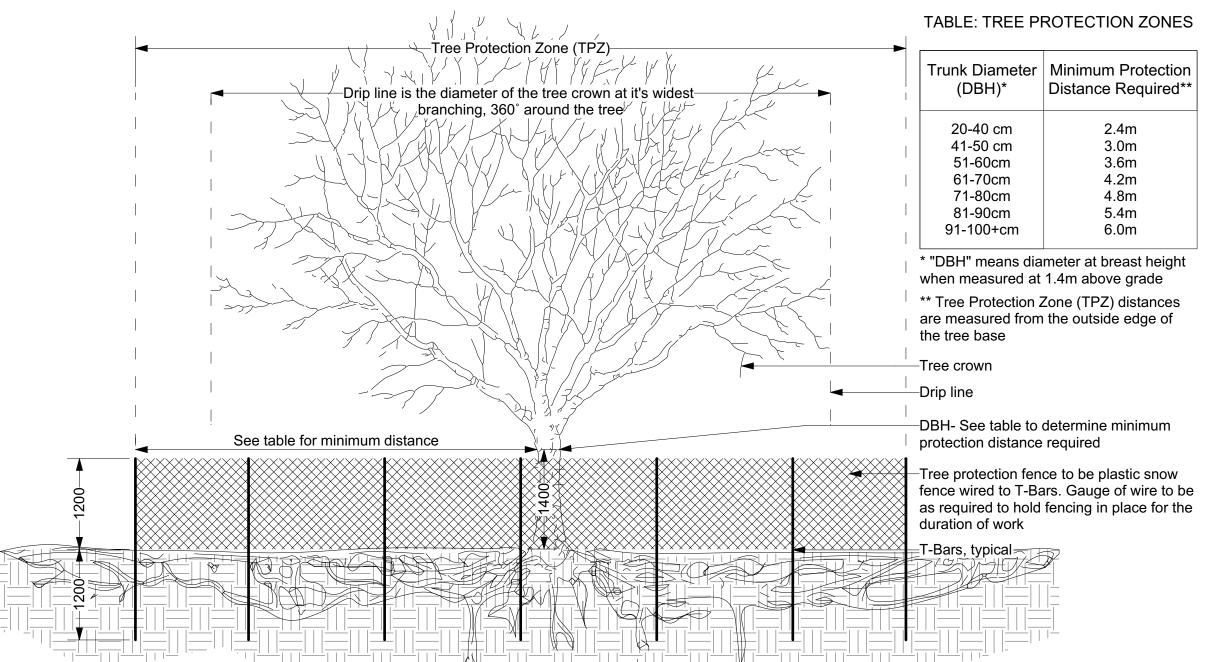

Tree Protection Fence

2 Scale: 1:50

#### **General Tree Protection Notes**

- 1. All dimensions shown in millimetres.
- 2. This detail does not represent any particular tree species.
- 3. No construction activity, grade changes, surface treatment, compaction, excavation or stockpiling of any kind is permitted within the protected area unless noted otherwise on the drawings and confirmed during pre-construction meeting.
- 4. Maintain (Mow as required and when directed by contract administrator) existing vegetative cover within fenced area during construction.
- 5. Tree protection to remain in place for duration of construction.
- 6. Tree protection to be adjusted only when needed to complete those activities shown within TPZ. Upon completion tree protection shall be reinstated in consultation with the project arborist.
- 7. No contaminants will be dumped or flushed where feeder roots of protected trees exist.
- 8. No rigging cables will be wrapped around or installed in trees and/or protected areas.
- 9. The developer and/or contractor will take every precaution necessary to prevent damage to trees, shrubs or other plants to be

retained.

10. Construction activities shown within the TPZ shall be conducted under the guidance and in consultation with an approved ISA Certified Arborist.

PROTECTION and PRESERVATION OF EXISTING VEGETATION

\* Tree Inventory and assesment completed by Gina Brouwer, ISA Certified Arborist ON-0937A (20-12-18) locations based on field review and survey by J.D. Barnes Ltd

All existing trees and other plants which are to remain shall be fully protected with hoarding (i.e. snow fencing) erected beyond their 'drip line' prior to the issuance of the Building Permit, to the satisfaction of the Planning and Development Department. Areas within the fencing shall remain undisturbed and shall not be used for the storage of building

**TOTAL NEW TREES: 36** 

No rigging cables shall be wrapped around or installed in trees and surplus soil, equipment debris or materials shall not be placed over root systems of the trees within the protective fencing. No contaminants will be dumped or flushed where feeder roots of trees exist.

The developer or his/her agents shall take every precaution necessary to prevent damage to trees or shrubs to be retained.

Where limbs or portions of trees are removed to accommodate construction work, they ill be removed carefully and in accordance with accepted arboricultural practices.

Where root systems of protected trees are exposed directly adjacent to construction work or damaged by said work, they shall be trimmed neatly and the area backfilled with appropriate material to prevent desiccation.

Where necessary, the trees will be given an overall pruning to restore the balance between roots and top growth or to restore the appearance of the trees.

Trees that have died or have been damaged beyond repair, shall be removed and replaced by the owner at his own expense with trees of a similar size, species and of equal value as approved by the Director of Planning and Development. Failure to replace damaged trees to a condition satisfactory to the Municipality shall result n the Municipality exercising its right to draw on the Letter of Credit.

If grades around trees to be protected are likely to change, the owner shall be required to take such precautions as dry welling, retaining walls and root feeding to the satisfaction of the Director of Planning and Development..

All excavation within the Tree Protection Zone (TPZ) around existing trees to be retained shall be hand dug.




DENOTES CATCHBASIN DICB DENOTES DITCH INLET CATCHBASIN DENOTES HANDWELL DENOTES TELEPHONE MANHOLE DENOTES SANITARY MANHOLE ◯ STM MH DENOTES STORM MANHOLE DENOTES HYDRO POLE DENOTES LIGHT STANDARD DENOTES TELEPHONE POLE DENOTES TRAFFIC SIGNAL □ PED DENOTES TELEPHONE PEDESTAL DENOTES FIRE HYDRANT DENOTES WATER KEY DENOTES WATER VALVE DENOTES OVERHEAD CABLES — T — DENOTES OVERHEAD TELEPHONE CABLES

- SAN-DENOTES UNDERGROUND SANITARY LINE — STM— DENOTES UNDERGROUND STORM LINE DENOTES BOTTOM OF SLOPE DENOTES TOP OF SLOPE S.T.E. DENOTES SUBJECT TO EASEMENT Client Review 20.12.11 TR Client Review 21.01.04 TR Client Review

21.01.05 TR 21.01.21 TR # # # # # # # #

Date By Description Issue / Revision Schedule



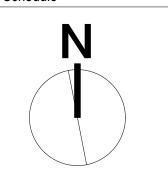

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Client:


2779471 Ontario Inc.


Proposed Multi-Residential Development 2345-2349 Highway #2, Bowmanville, ON

Drawing Title:

Tree Protection Plan

Designed By: TR Project #: 20088 Drawn By: TR Drawing #: Approved By: GB

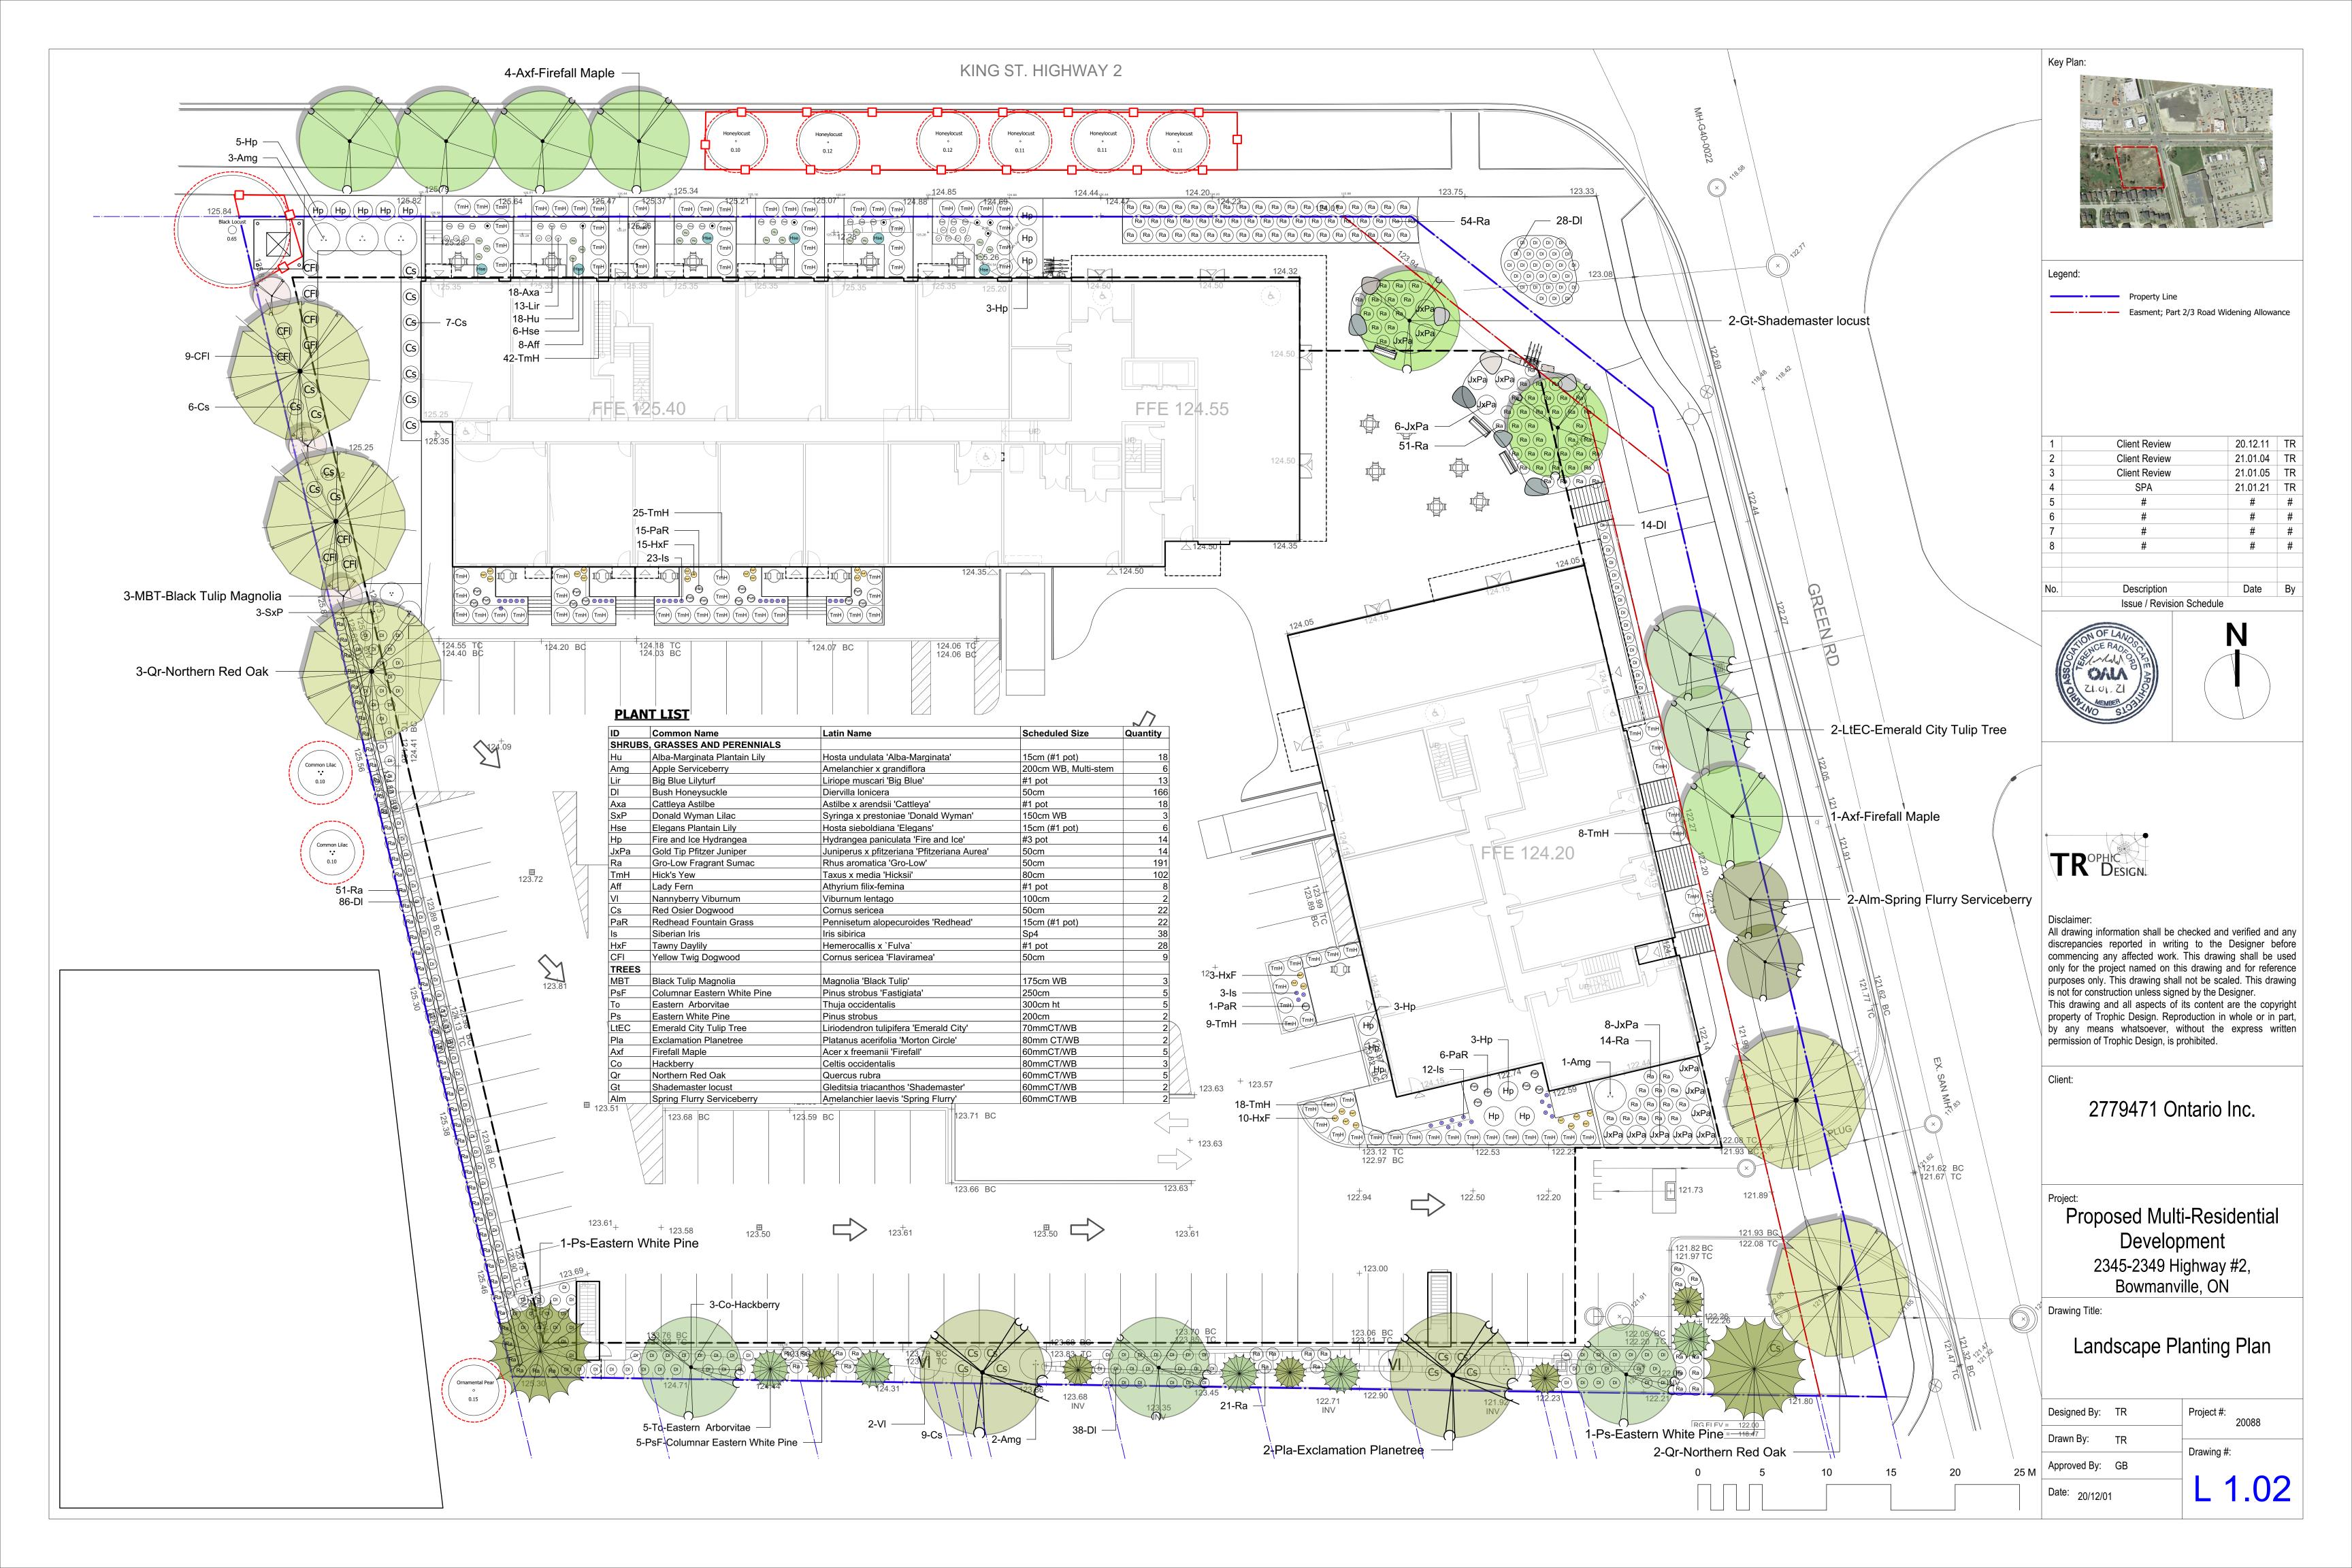

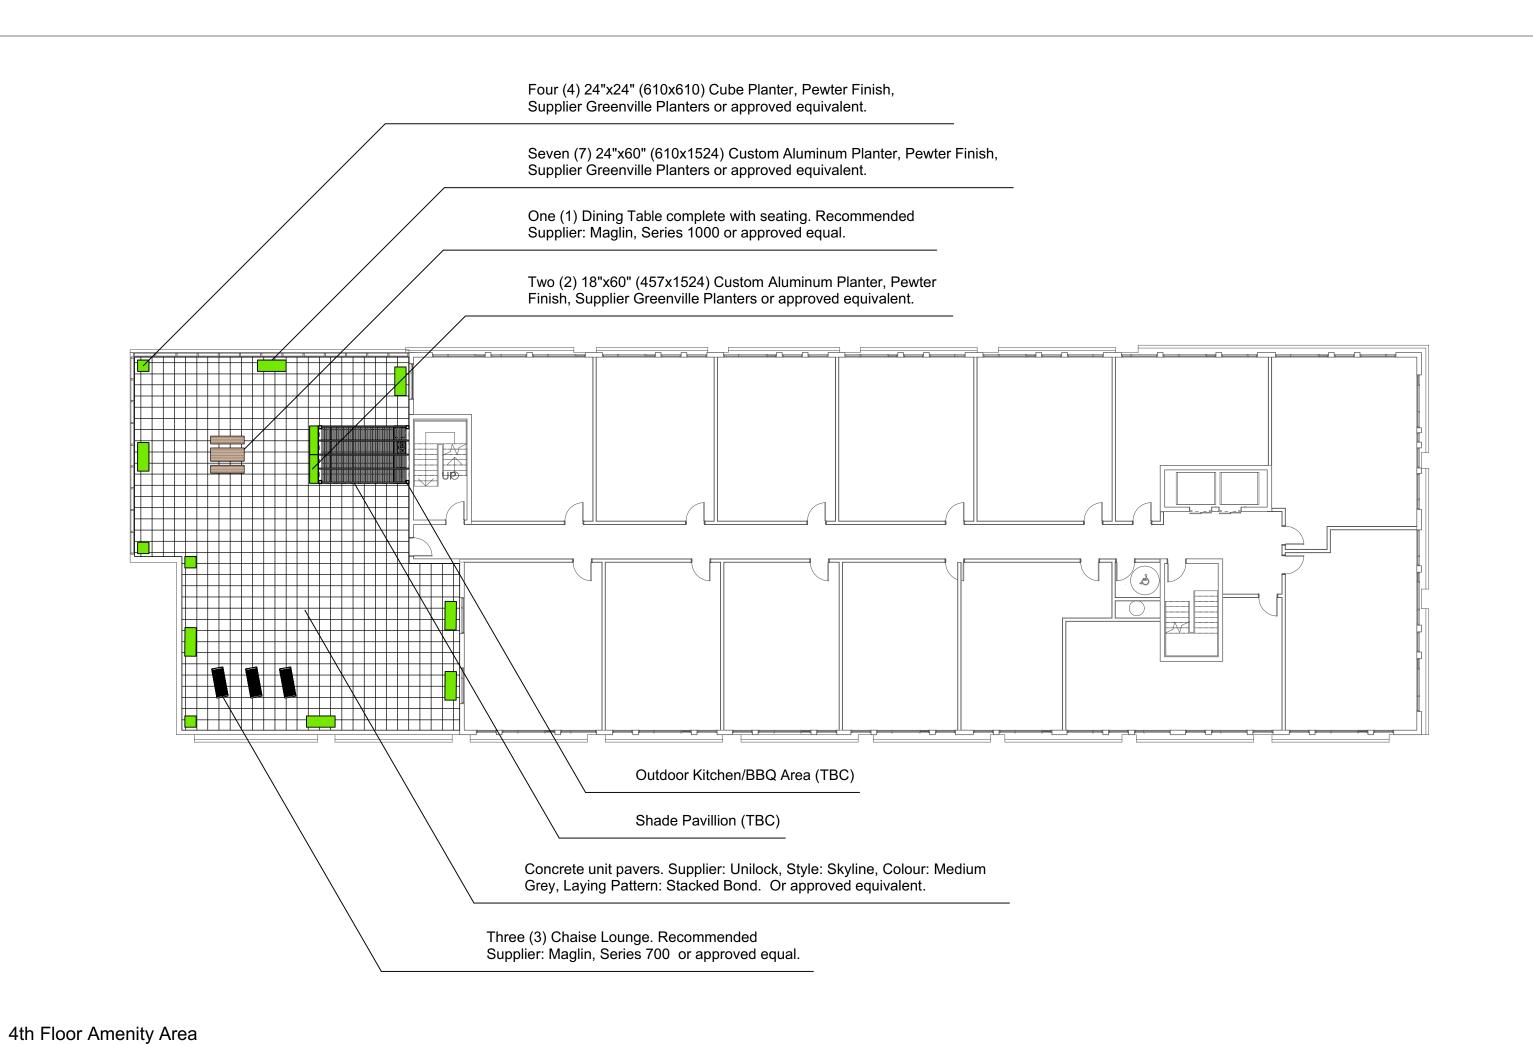

LANDSCAPE MATERIALS Powder Coated Aluminum Planter Custom Aluminum Planter 36" (914) height typical, width and depth as noted, Pewter Finish, Supplier Greenville Planters or approved equivalent. Potting Mix, 450 mm depth. Planters to be voided with high density foam as All planters to be irrigated with micro sprays. Each Amenity Area to be provided with one hose end System to be designed to connect to exterior hose bib. Powder Coated Aluminum Cube Planter Aluminum Cube Planter width and depth as noted, 36" Two (2) Chaise Lounge. Recommended Supplier: (914) height typicall, Pewter Finish, Supplier Greenville Maglin, Series 700 or approved equal. Planters or approved equivalent. Potting Mix, 450 mm depth typ. Planters to be voided with high density foam as needed. All planters to be irrigated with micro sprays. Each Amenity Area to be provided with one hose end System to be designed to connect to directly exterior Fourteen (7) 24"x24" (610x610) Cube Planter, Pewter Finish, Supplier Greenville Planters or approved equivalent. Concrete unit pavers. Supplier: Unilock, Style: Skyline, Colour: Medium Grey, Laying Pattern: Stacked Bond. Or approved equivalent.

LEGEND


Replan:

Legend:


Property Line
Easment; Part 2/3 Road Widening Allowance

d. 36"
renville

The Client Review 20.12.11 TR
Client Review 21.01.04 TR
Client Review 21.01.05 TR
SPA 21.01.21 TR

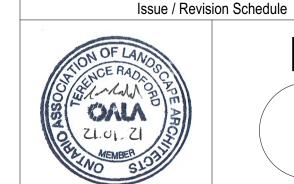

Description

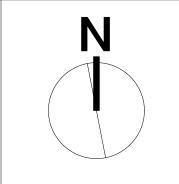

# #

Date By

NO SIS



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Client:

2779471 Ontario Inc.

Project:

Proposed Multi-Residential
Development
2345-2349 Highway #2,
Bowmanville, ON

Drawing Title:

Landscape Roof Plans


Designed By: TR Project #: 20088

Drawn By: TR Drawing #:


Approved By: GB

Date: 20/12/01

L 1.03

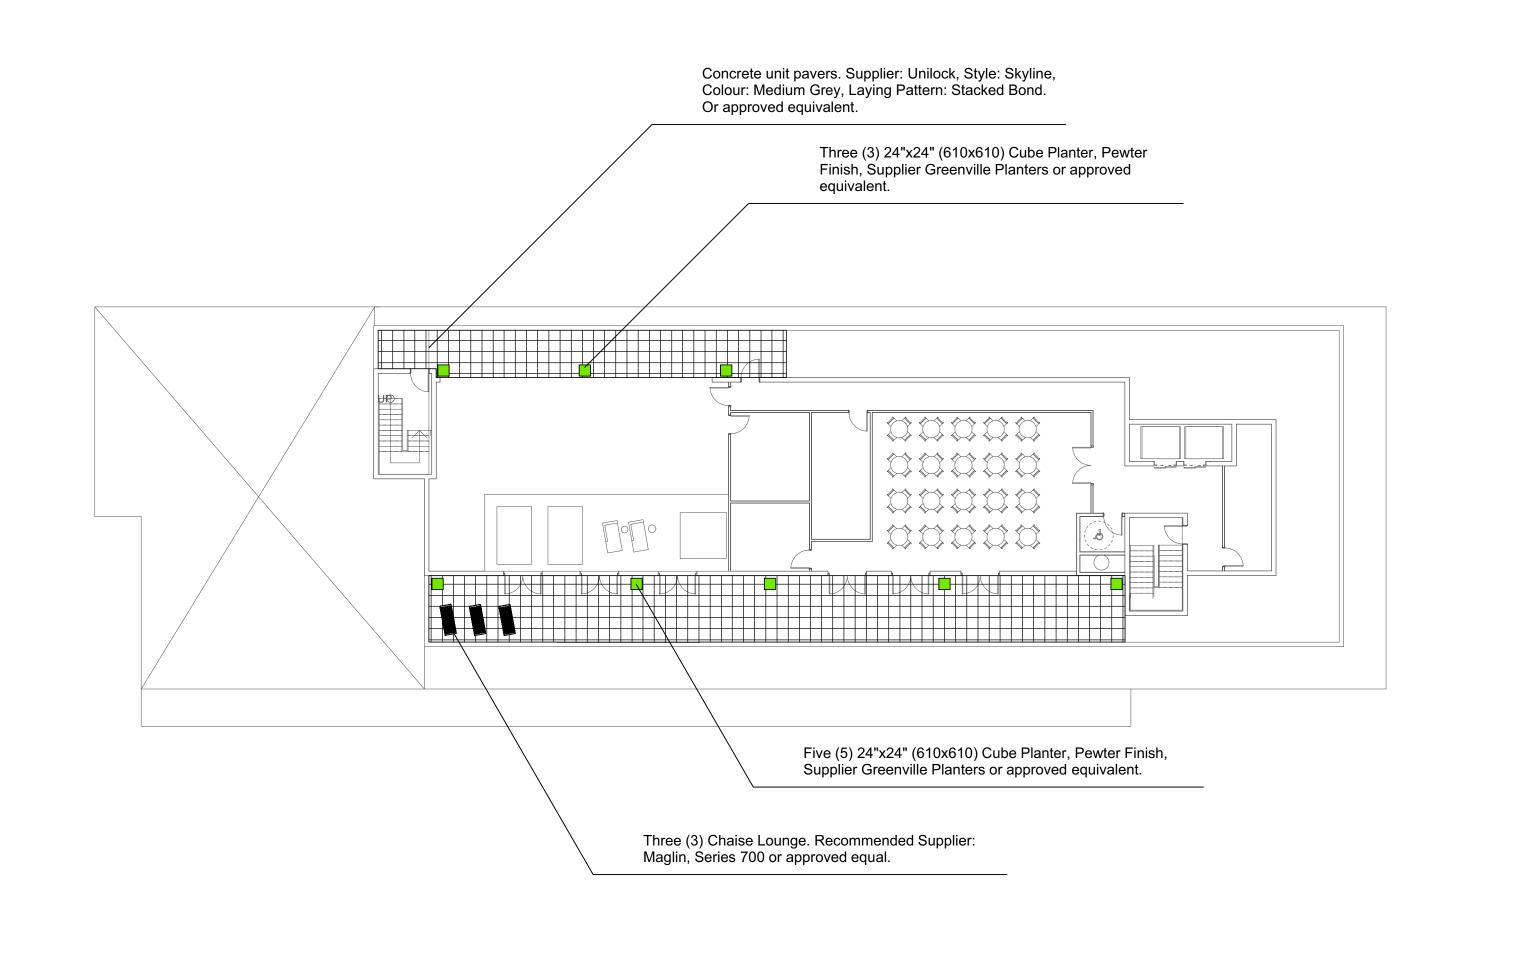

Phase 1- Roof Top Amenity Area

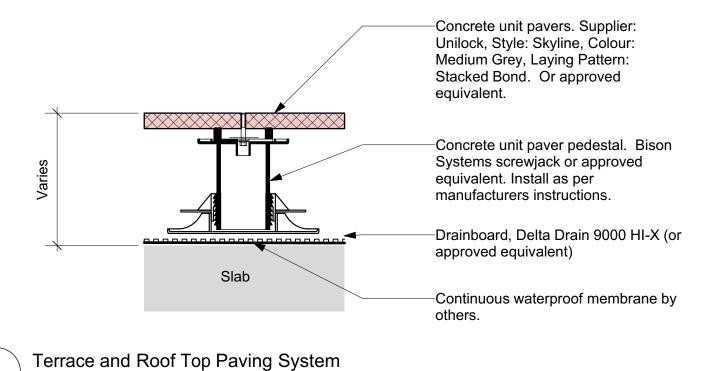

4 Terrace and Roof Top Scale: 1:10

#### PLANTING NOTES

Phase 2- Roof Top Amenity Area

3 Scale: 1:200

- 1. Planting in roof top planters to be determined based on available soil volumes. It is assumed planting will consist of ornamental grasses, perennials and small shrubs.
- Roof plantings in planters will not be warrantied by landscape contractor. It is assumed that plant maintenance will be handled independently by developer until unit sales. Upon sale responsibility will be the owners association.
- 3. Each amenity area will have an independent irrigation system for the roof planters. Irrigation will consist of micro sprays and a hose end controller.
- controller.

  4. Each amenity areas irrigation system to connect directly to exterior hose bib (see architects plans).
- equivalent) powder coat finish. Supplier: Greenville Planters or LA approved alternate.

  6 Planters to be typically 24"y60" (610y1524) and 36" (914) in height


5. All planters to be constructed of aluminum with a pewter (or


- 6. Planters to be typically 24"x60" (610x1524) and 36" (914) in height, unless otherwise noted.
  7. Planters to be installed on pedestals or directly on unit paving.
- 8. All planters to be filled with high density foam or other suitable voiding material to limit maximum soil depth. Structural engineer to confirm maximum soil depth (assumed 450mm).
- 9. All planters to be filled with an approved potting mix. Contractor to provide product sample for approval prior to purchase.
- Final planter numbers and locations to be coordinated with the structural engineer. Planters quantities and layout may differ from those shown for SPA.

#### DRAWING NOTES TYPICAL


- DO NOT SCALE DRAWING: Verify all property lines and existing structures/vegetation to remain, prior to commencing work.
   All plan dimensions in metres and all detail dimensions in millimeter.
- All plan dimensions in metres and all detail dimensions in millimetres.
   Plant quantities on Plans shall take precedence over plant list quantities.
- 4. Contractor to confirm location and elevation of all existing services and utilities prior to start of construction.
- 5. Provide layout of all work for approval by Landscape Architect prior to proceeding with work.6. Contractor to provide irrigation system for all landscape areas to
- current IIABC Standards and Contract Specifications.

  7. Landscape installation to carry a 1 year warranty from date of
- acceptance.
- 8. Plant material, installation and maintenance to conform to the current edition of the Canadian Landscape Standard.9. General Contractor and/or sub-contractors are responsible for all costs
- related to production and submission to consultant of all landscape as-built information including irrigation.
- 10. Tree protection fencing, for existing trees, to be installed prior to commencement of all site work

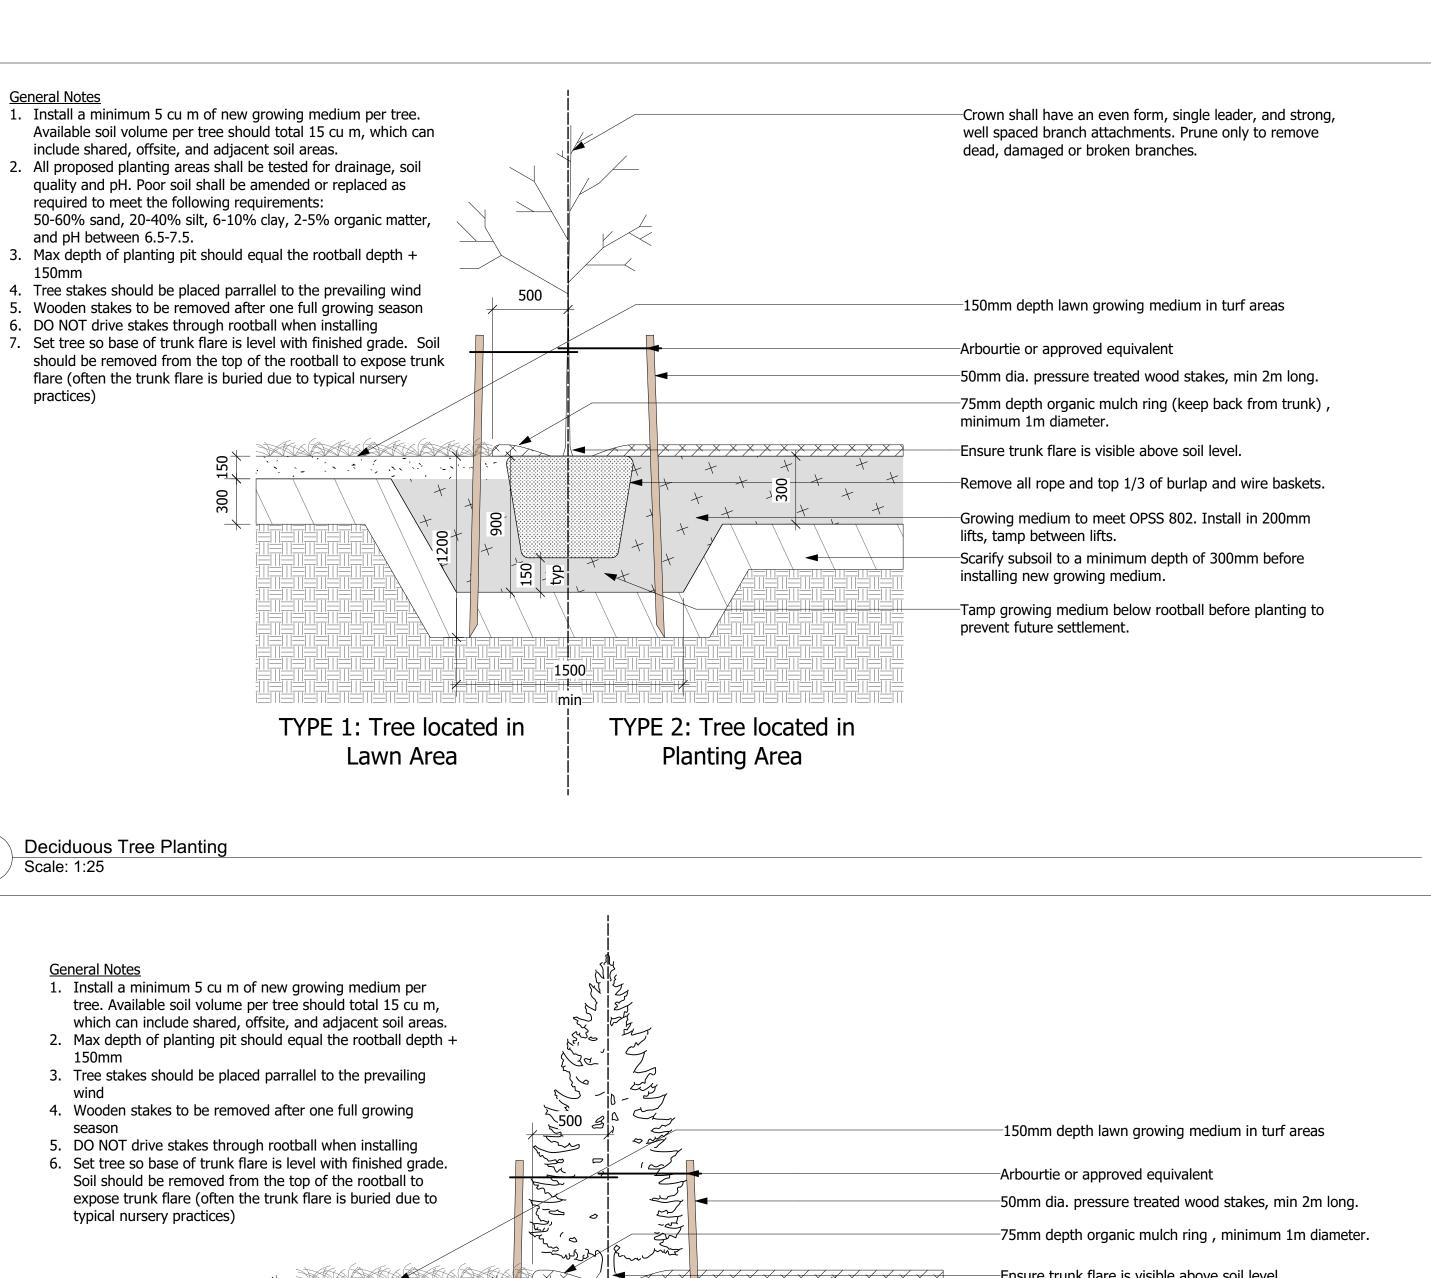

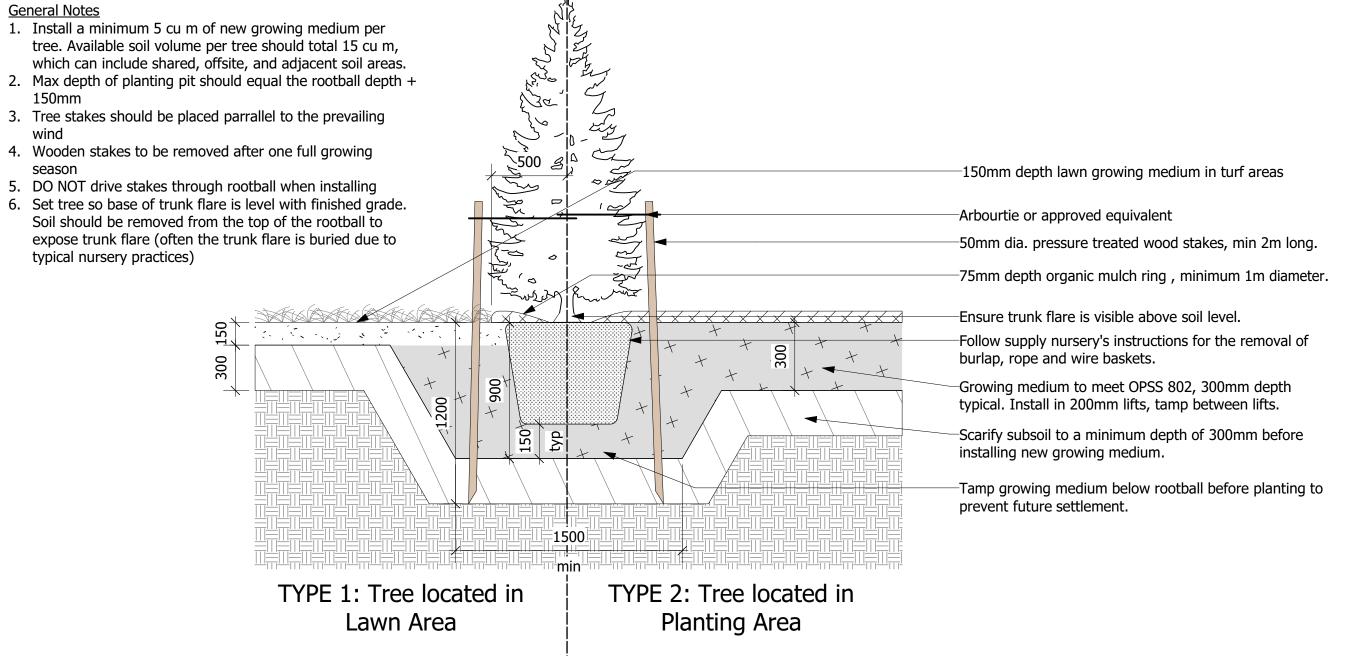

Coniferous Tree Planting

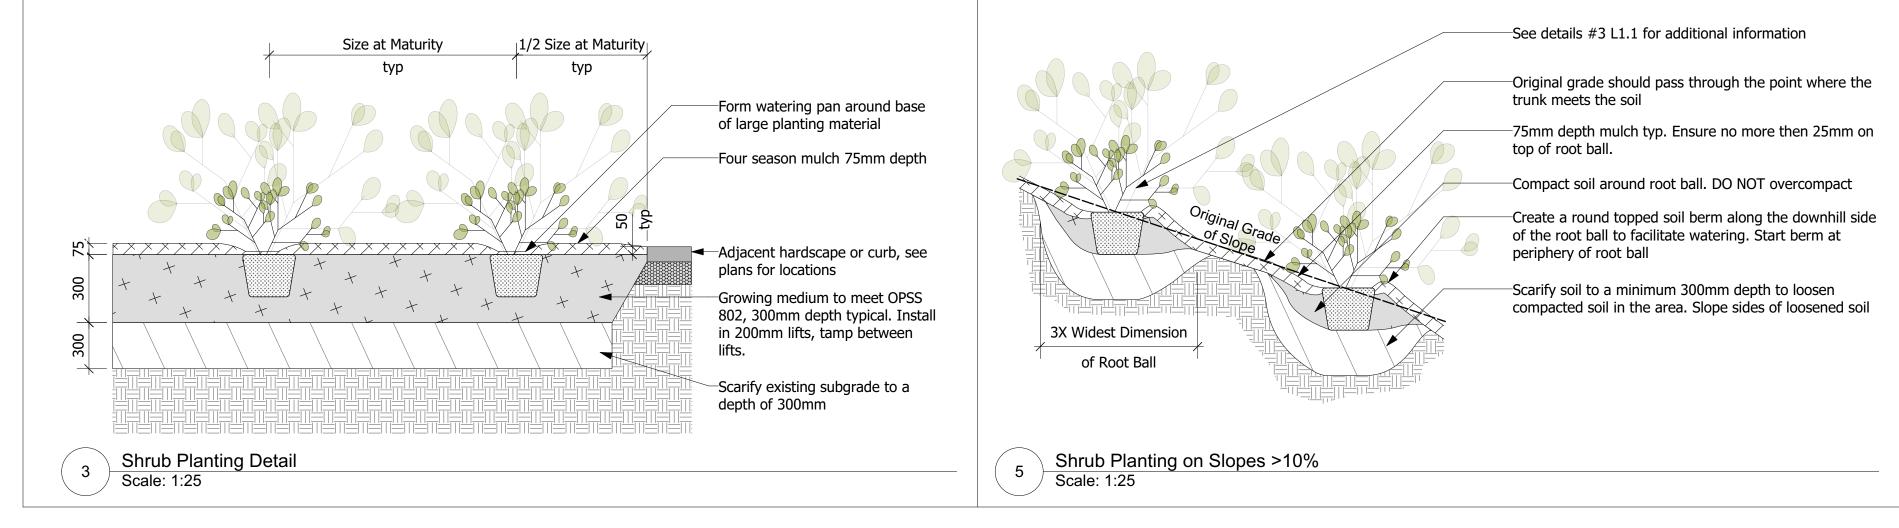

#### **LANDSCAPE NOTES:**

The Contractor shall review all existing conditions and utilities prior to commencement of work. Protect all existing plant material, structures and adjacent areas from damage. Layout shall be approved by the Contract Administrator prior to commencement of work. See plant list on DWG L1.02

#### TOPSOIL & SOD

Sod all areas disturbed during removals and planting. Topsoil and sod shall meet the requirements of OPSS 802, 804 and 805, in addition to meeting any additional requirements set out in these specifications. Boulevards shall have 2% positive drainage toward the curb and shall be fully sodded, except for areas covered by driveway aprons or sidewalk.

All new topsoil shall be free from native till or clay, roots, vegetation, weeds or debris, stones and clods over 50mm diameter. Imported topsoil, if required, shall be fertile, loamy, screened material of a quality acceptable to the Director (containing approx. 4% organic matter for clay loams and 2% organic matter for sandy loams with acidity range of 6.0 Ph). Topsoil infested by the seeds of noxious weeds will not be acceptable.

All sod shall meet the requirements of Ontario Sod Grower's Association No. 1 Bluegrass Fescue Nursery Sod. The sod shall be taken from good loamy soil and shall be healthy, well permeated with roots, have uniform texture and appearance and be free from weeds. Sod must be laid within thirty-six (36) hours of being cut. Care must be taken during its transportation and placement to prevent any drying out. Sod shall match flush with all adjacent surfaces and shall have no open gaps, overlapping edges or uneven joints. Where adjacent or fronting lands have already been sodded, care must be taken to ensure drainage is maintained and a smooth transition is achieved.

Laid sod shall be immediately rolled to produce an even surface and watering shall commence immediately thereafter and shall continue on a regular basis until healthy roots are well established and permanent. If sod fails to establish immediately, it shall be removed and replaced. No attempt shall be made to try to re-establish weak/dead sod through continual watering, unless specific permission is granted by the Director. The entire work shall be done in a thoroughly workmanlike manner with an even surface, and professional in appearance. Any sod deemed unfit by the Director shall be immediately removed from the site and replaced.

#### PROTECTION and PRESERVATION OF EXISTING VEGETATION

All existing trees and other plants which are to remain shall be fully protected with hoarding (i.e. snow fencing) erected beyond their 'drip line' prior to the issuance of the Building Permit, to the satisfaction of the Planning and Development Department. Areas within the fencing shall remain undisturbed and shall not be used for the storage of building materials or equipment.

No rigging cables shall be wrapped around or installed in trees and surplus soil, equipment debris or materials shall not be placed over root systems of the trees within the protective fencing. No contaminants will be dumped or flushed where feeder roots of

The developer or his/her agents shall take every precaution necessary to prevent damage to trees or shrubs to be retained.

Where limbs or portions of trees are removed to accommodate construction work, they ill be removed carefully and in accordance with accepted arboricultural practices.

Where root systems of protected trees are exposed directly adjacent to construction work or damaged by said work, they shall be trimmed neatly and the area backfilled with appropriate material to prevent desiccation.

Where necessary, the trees will be given an overall pruning to restore the balance between roots and top growth or to restore the appearance of the trees.

Trees that have died or have been damaged beyond repair, shall be removed and replaced by the owner at his own expense with trees of a similar size, species and of equal value as approved by the Director of Planning and Development. Failure to replace damaged trees to a condition satisfactory to the Municipality shall result in the Municipality exercising its right to draw on the Letter of Credit.

If grades around trees to be protected are likely to change, the owner shall be required to take such precautions as dry welling, retaining walls and root feeding to the satisfaction of the Director of Planning and Development.

All plant material shall be nursery grown, true to type, conforming to the current edition of the Canadian Nursery Landscape Association's Canadian Standards for Nursery Stock. All plants shall be healthy and vigorous with all parts free from defects, decay, disfigurement, injury, disease and pests.

All trees shall have a reasonably straight trunk, free of any decay or wounds. Trees shall have a balanced canopy with a minimum of 12 branches. The branching height shall be a minimum of 1.8m from the root ball. Columnar trees shall possess one main trunk and no multiple competing stems. Branching shall be uniform and characteristic of the growing habit for the species. The root ball shall be a minimum of 750mm in diameter and shall have a depth of 2/3 the diameter. The root ball must be solid with little or no movement at the trunk and free of girdling roots.

Prior to any trees arriving on site, an onsite meeting between the landscaper, contractor, and Developer's Landscape Architect must be held to review planting locations and procedures. The Developer's landscaper shall ensure that trees are planted under ideal seasonal conditions and according to the following procedures:

- All tree pits shall be prepared in accordance with Clarington Tree Planting Detail C-508. Trees shall be placed so that the root flare is 50mm above the finished boulevard grade. Sub-grade levels will not be
- accepted. The ball or basket must be untied with the trunk free from choking ties. All trunk wrap must be removed after planting. The top 1/3 of the wire basket and burlap must be removed, (not bent down). The remainder of the basket must be clipped randomly throughout the remaining 2/3. Waste from these procedures shall be properly disposed of off site. The hole shall be backfilled halfway with a blended mix of topsoil. The hole shall be backfilled and compacted to remove all air pockets and to ensure the tree is stable without the installation of tree stakes.
- The tree planting pit surface and all planting beds shall be mulched with 75mm of shredded bark mulch. Wood chips will not be accepted. Mulch must not be placed against the trunk of the tree. A sample of mulch shall be submitted for approval.

The Contract Administrator may reject any plant material, whether planted or not, that does not conform to the specifications. Substitutions for specified plants will not be accepted unless approved in writing by the Contract Administrator. Plant material shall be unwrapped prior to inspection with labels left on. The Contract Administrator shall inspect and provide written acceptance of

The Municipality reserves the right to investigate, inspect and reject any substandard material, tree or procedure at any time during, or subsequent to, the planting process. Immediately following planting, each tree shall be inspected for damage. Damaged trees shall be replaced or treated n accordance with proper horticultural standards, as directed.

The Developer's landscaper shall implement an ongoing maintenance program of all trees and plant material and shall monitor their progress at 3 and 12 months. Any trees showing signs of distress shall be treated or replaced immediately, as directed. The Contractor shall maintain all plant material and assume full responsibility for protection of all planted areas until final acceptance of all project work at the end of the specified warranty period (1 year). The Contractor shall water plants as necessary with sufficient quantities to maintain healthy growth.

All plants that are dead, or not in healthy, satisfactory growing condition, or which in any way do not meet the specifications, shall be replaced within two weeks of notification at the Contractor's expense

The Contractor shall remove all stakes and staking material at the end of the warranty period. The Contract Administrator shall inspect and provide final acceptance.

Key Plan:



Legend:

1	Client Review	20.12.11	TR
2	Client Review	21.01.04	TR
3	Client Review	21.01.05	TR
4	SPA	21.01.21	TR
5	#	#	#
6	#	#	#
7	#	#	#
8	#	#	#

Description Date By Issue / Revision Schedule





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Client:


2779471 Ontario Inc.


Proposed Multi-Residential Development 2345-2349 Highway #2, Bowmanville, ON


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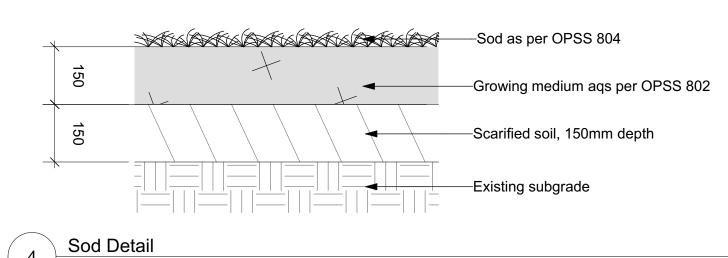
Landscape Details

Designed By:	TR	Project #: 20088
Drawn By:	TR	Drawing #:
Approved By:	GB	Drawing #.




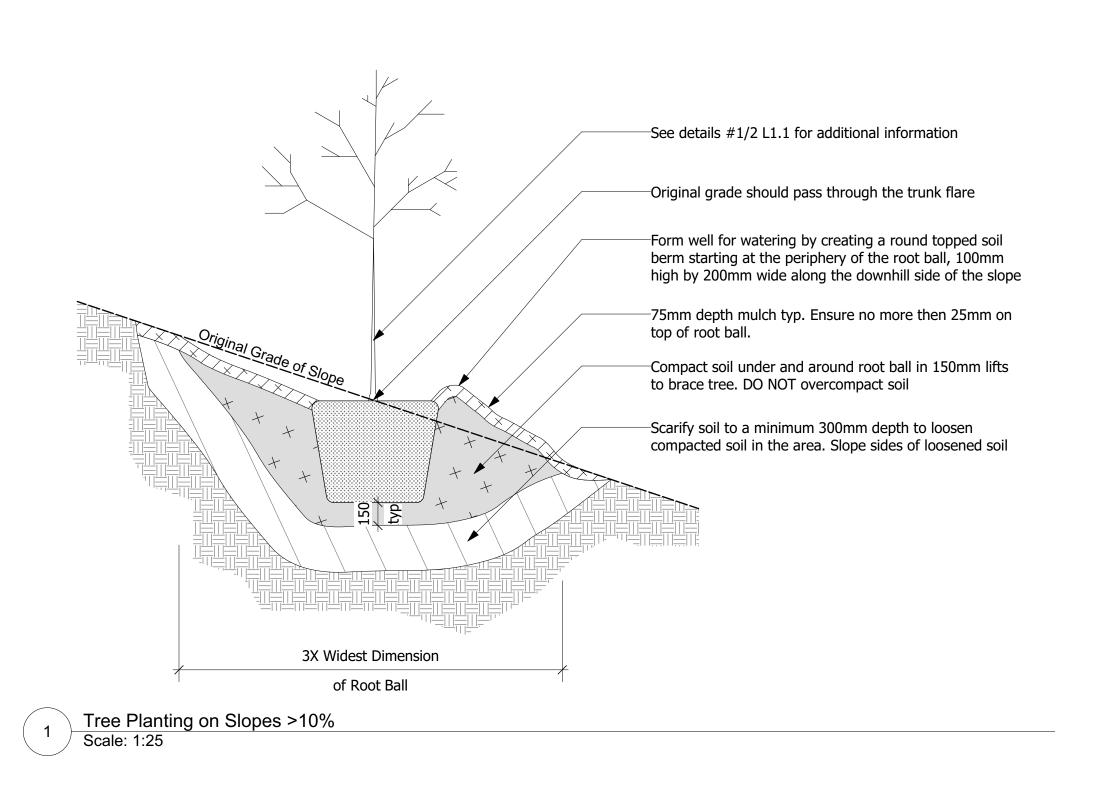

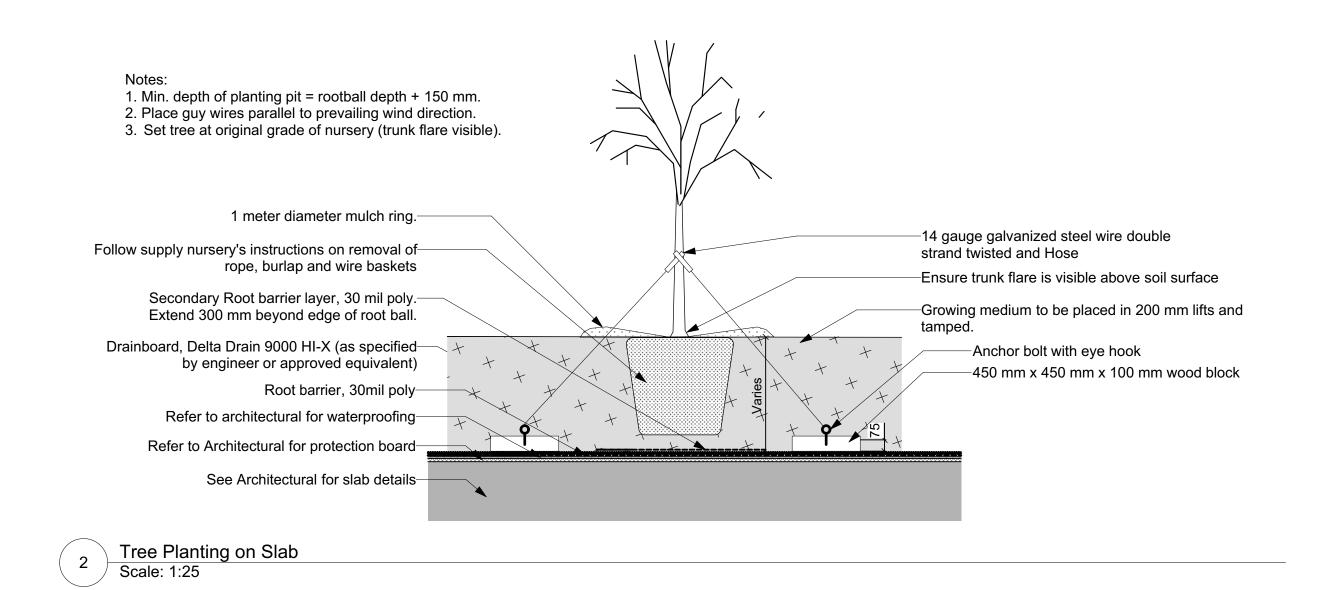

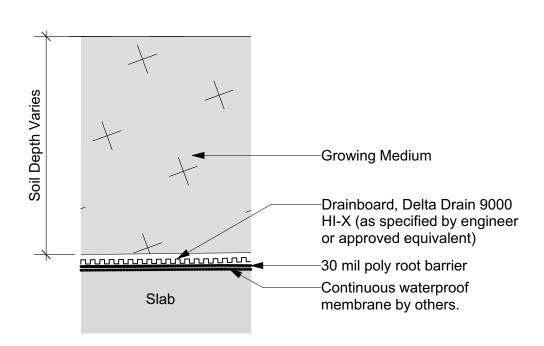


Landscape on Slab Assembly
Scale: 1:10

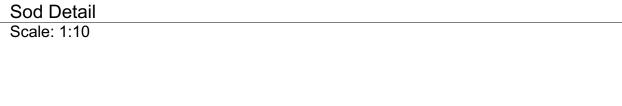

**ELEVATION** 

8 Scale: 1:10

Bike Rack Detail

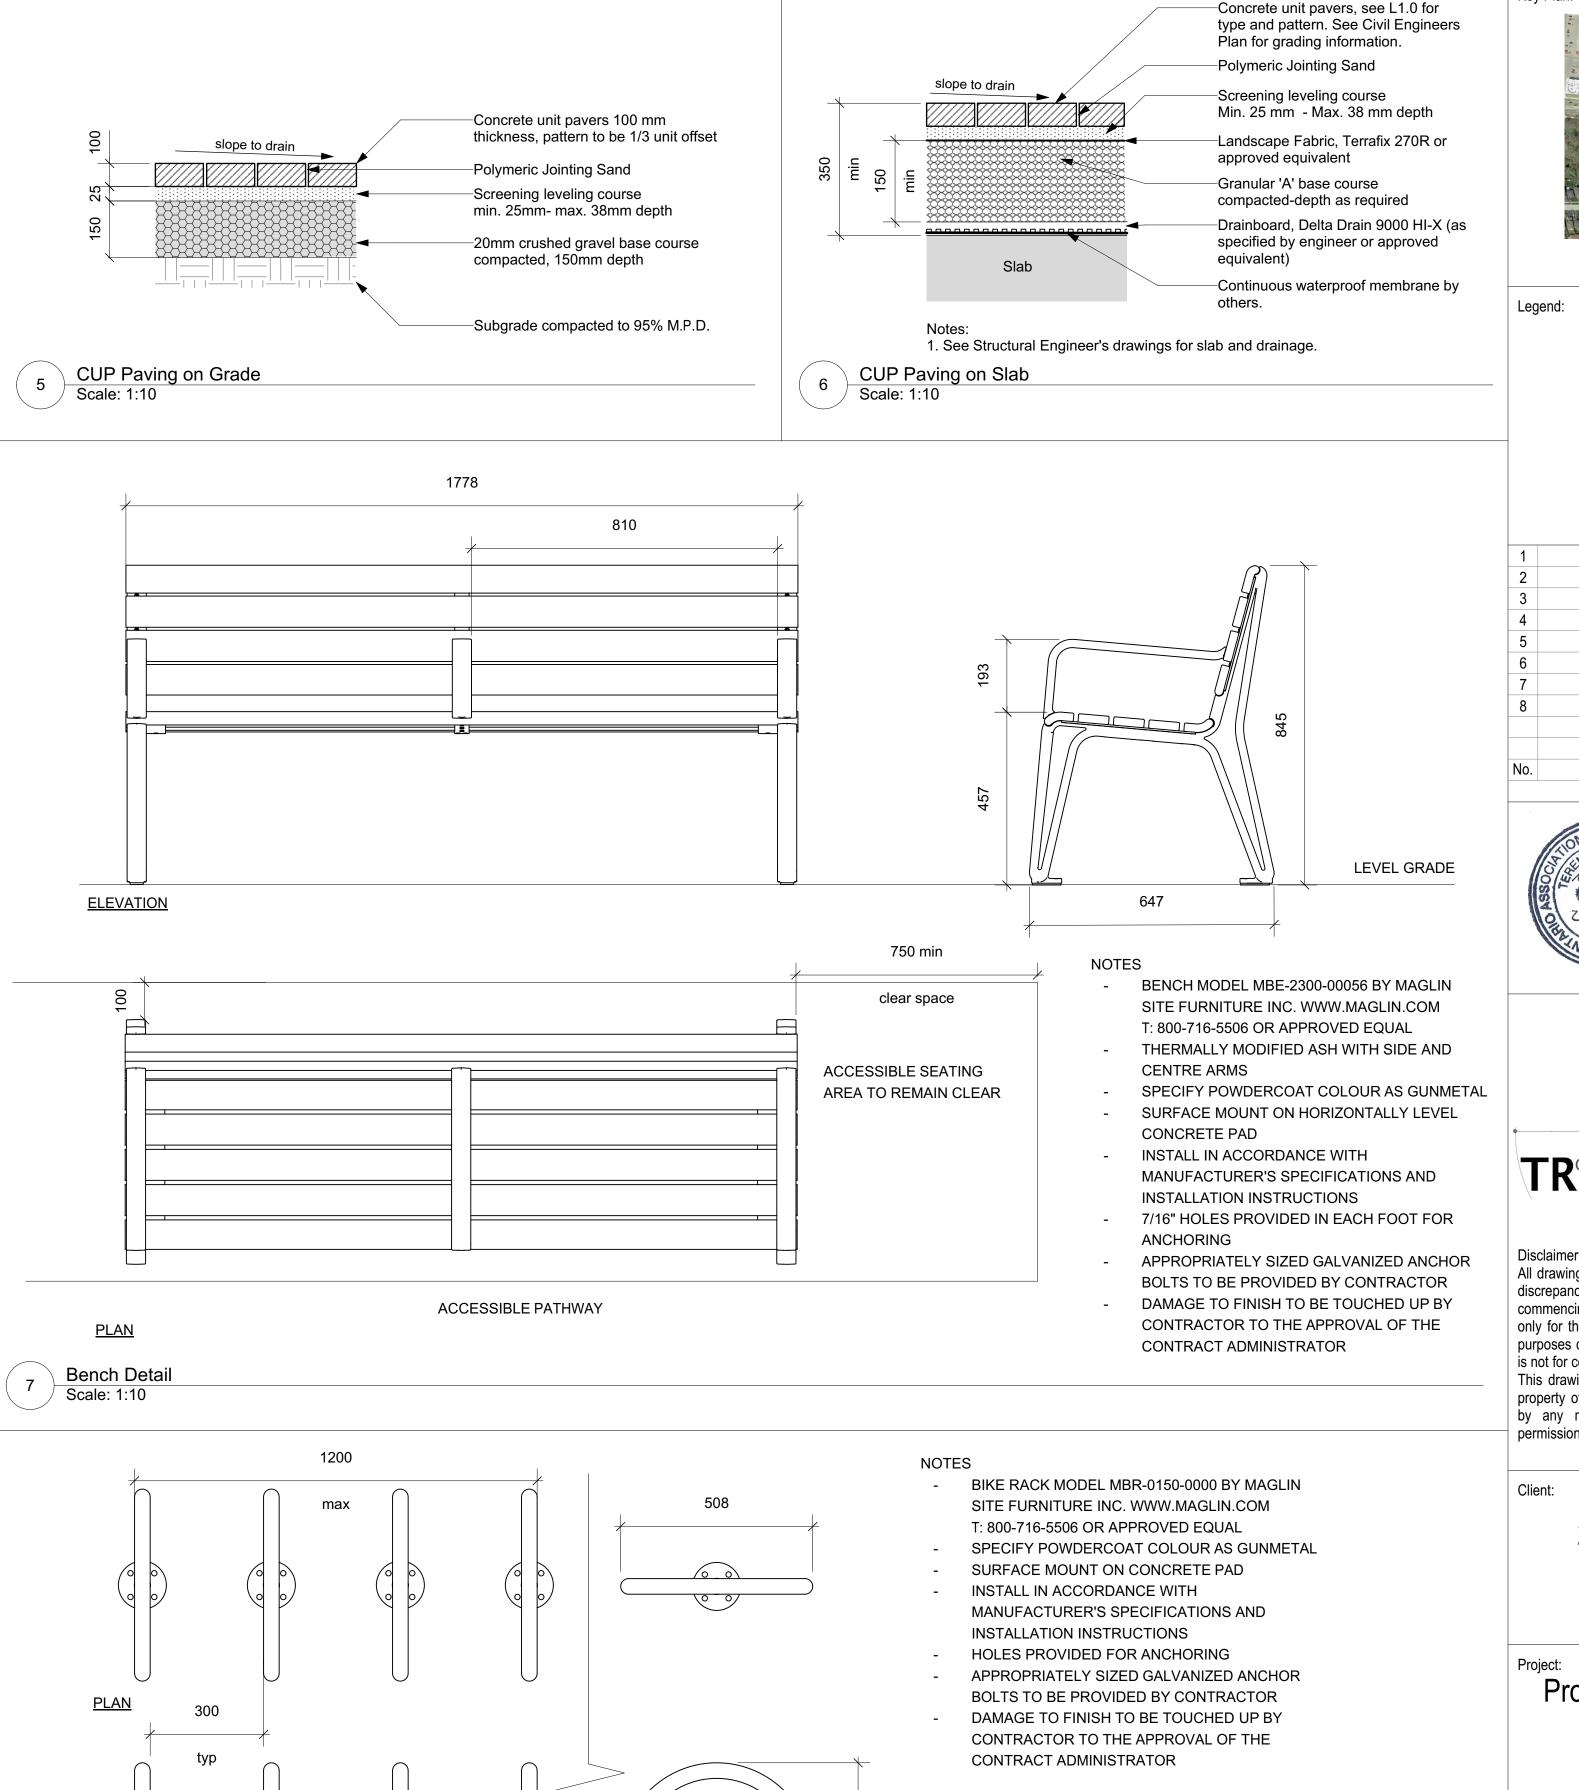

Bowmanville, ON

Landscape Details

Designed By:	TR	Project #: 20088
Drawn By:	TR	Drowing #
Approved By:	GB	Drawing #:
		1 1 7

Key Plan:

No.	Description	Date	Ву
8	#	#	#
7	#	#	#
6	#	#	#
5	#	#	#
4	SPA	21.01.21	TR
3	Client Review	21.01.05	TR
2	Client Review	21.01.04	TR
1	Client Review	20.12.11	TR

Issue / Revision Schedule






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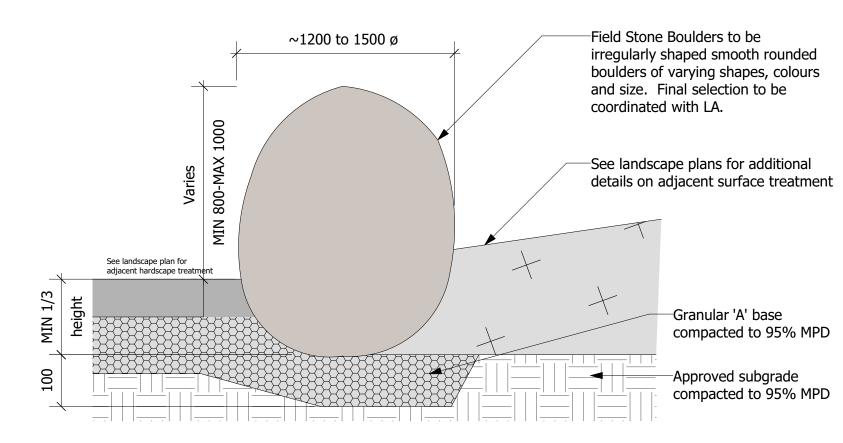
Drawing Title:



**Armour Stone Installation Notes** 

- 1. All dimensions are in millimeters. Do not scale drawing; 2. Specified depths of mulch and topsoil are depths after settlement. Specified depth of granular base is
- compacted depth; 3. Install all armour stone with a minimum 50mm below
- finished grade of adjacent surface; 4. Ensure that all armour stone are stable and free from all movement after installation is complete;
- 5. Gaps between adjacent armour stones are to be minimized to the greatest extent possible. Gaps are to
- be less than 50mm. 6. Gaps greater than 50mm shall be parged with a concrete mix or filled by alternative method to the satisfaction of the Landscape Architect. Contractor to approve method of filling prior to completing;
- 7. Ensure that all armour stone are installed with a maximum 2% slope;
- 8. Ensure all armour stone seating surfaces are level with
- adjacent armour stone; and
- 9. Installation of armour stone to be to the satisfaction of the Design Consultant and/or clients representative.

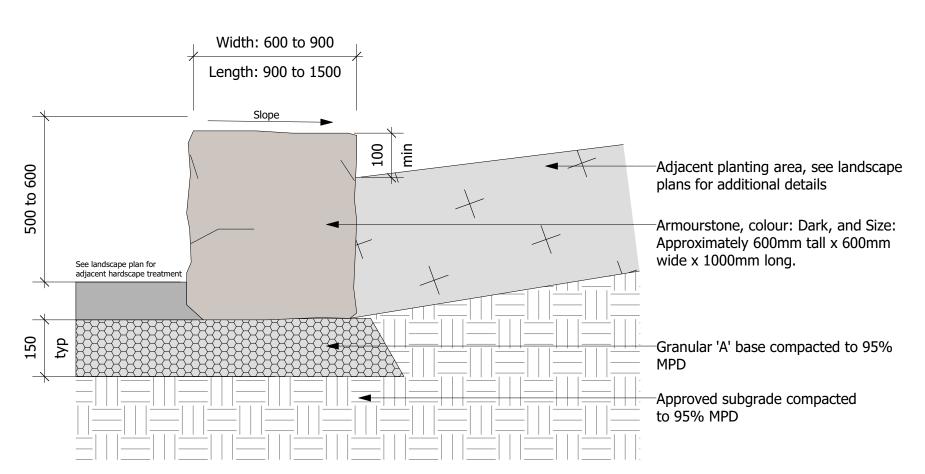Armour Stone Seating



Field Stone Boulder Installation Notes

- scale drawing;
- 2. Field Stone Boulders to be smooth
- 3. Install all boulders with a minimum 1/3 of
- 4. Ensure that all boulders are stable and free from all movement after installation
- 5. Boulders to be installed directly on prepared base;
- and presence of each stone. LA to coordinate placement and orientation
- with contractor; and

Field Stone Boulder Detail
Scale: 1:10

- 1. All dimensions are in millimeters. Do not
- rounded field stone of varying colour, shapes and sizes. LA to approver final selection of stones;
- height below finished grade of adjacent surface;
- is complete;
- 6. Boulders to be placed either in vertical or horizontal position to enhance character
- 7. Installation of boulders to be to the satisfaction of the Design Consultant and/or clients representative.

Key Plan:

Legend:

1	Client Review	20.12.11	TR
2	Client Review	21.01.04	TR
3	Client Review	21.01.05	TR
4	SPA	21.01.21	TR
5	#	#	#
6	#	#	#
7	#	#	#
8	#	#	#
No.	Description	Date	Ву

Issue / Revision Schedule





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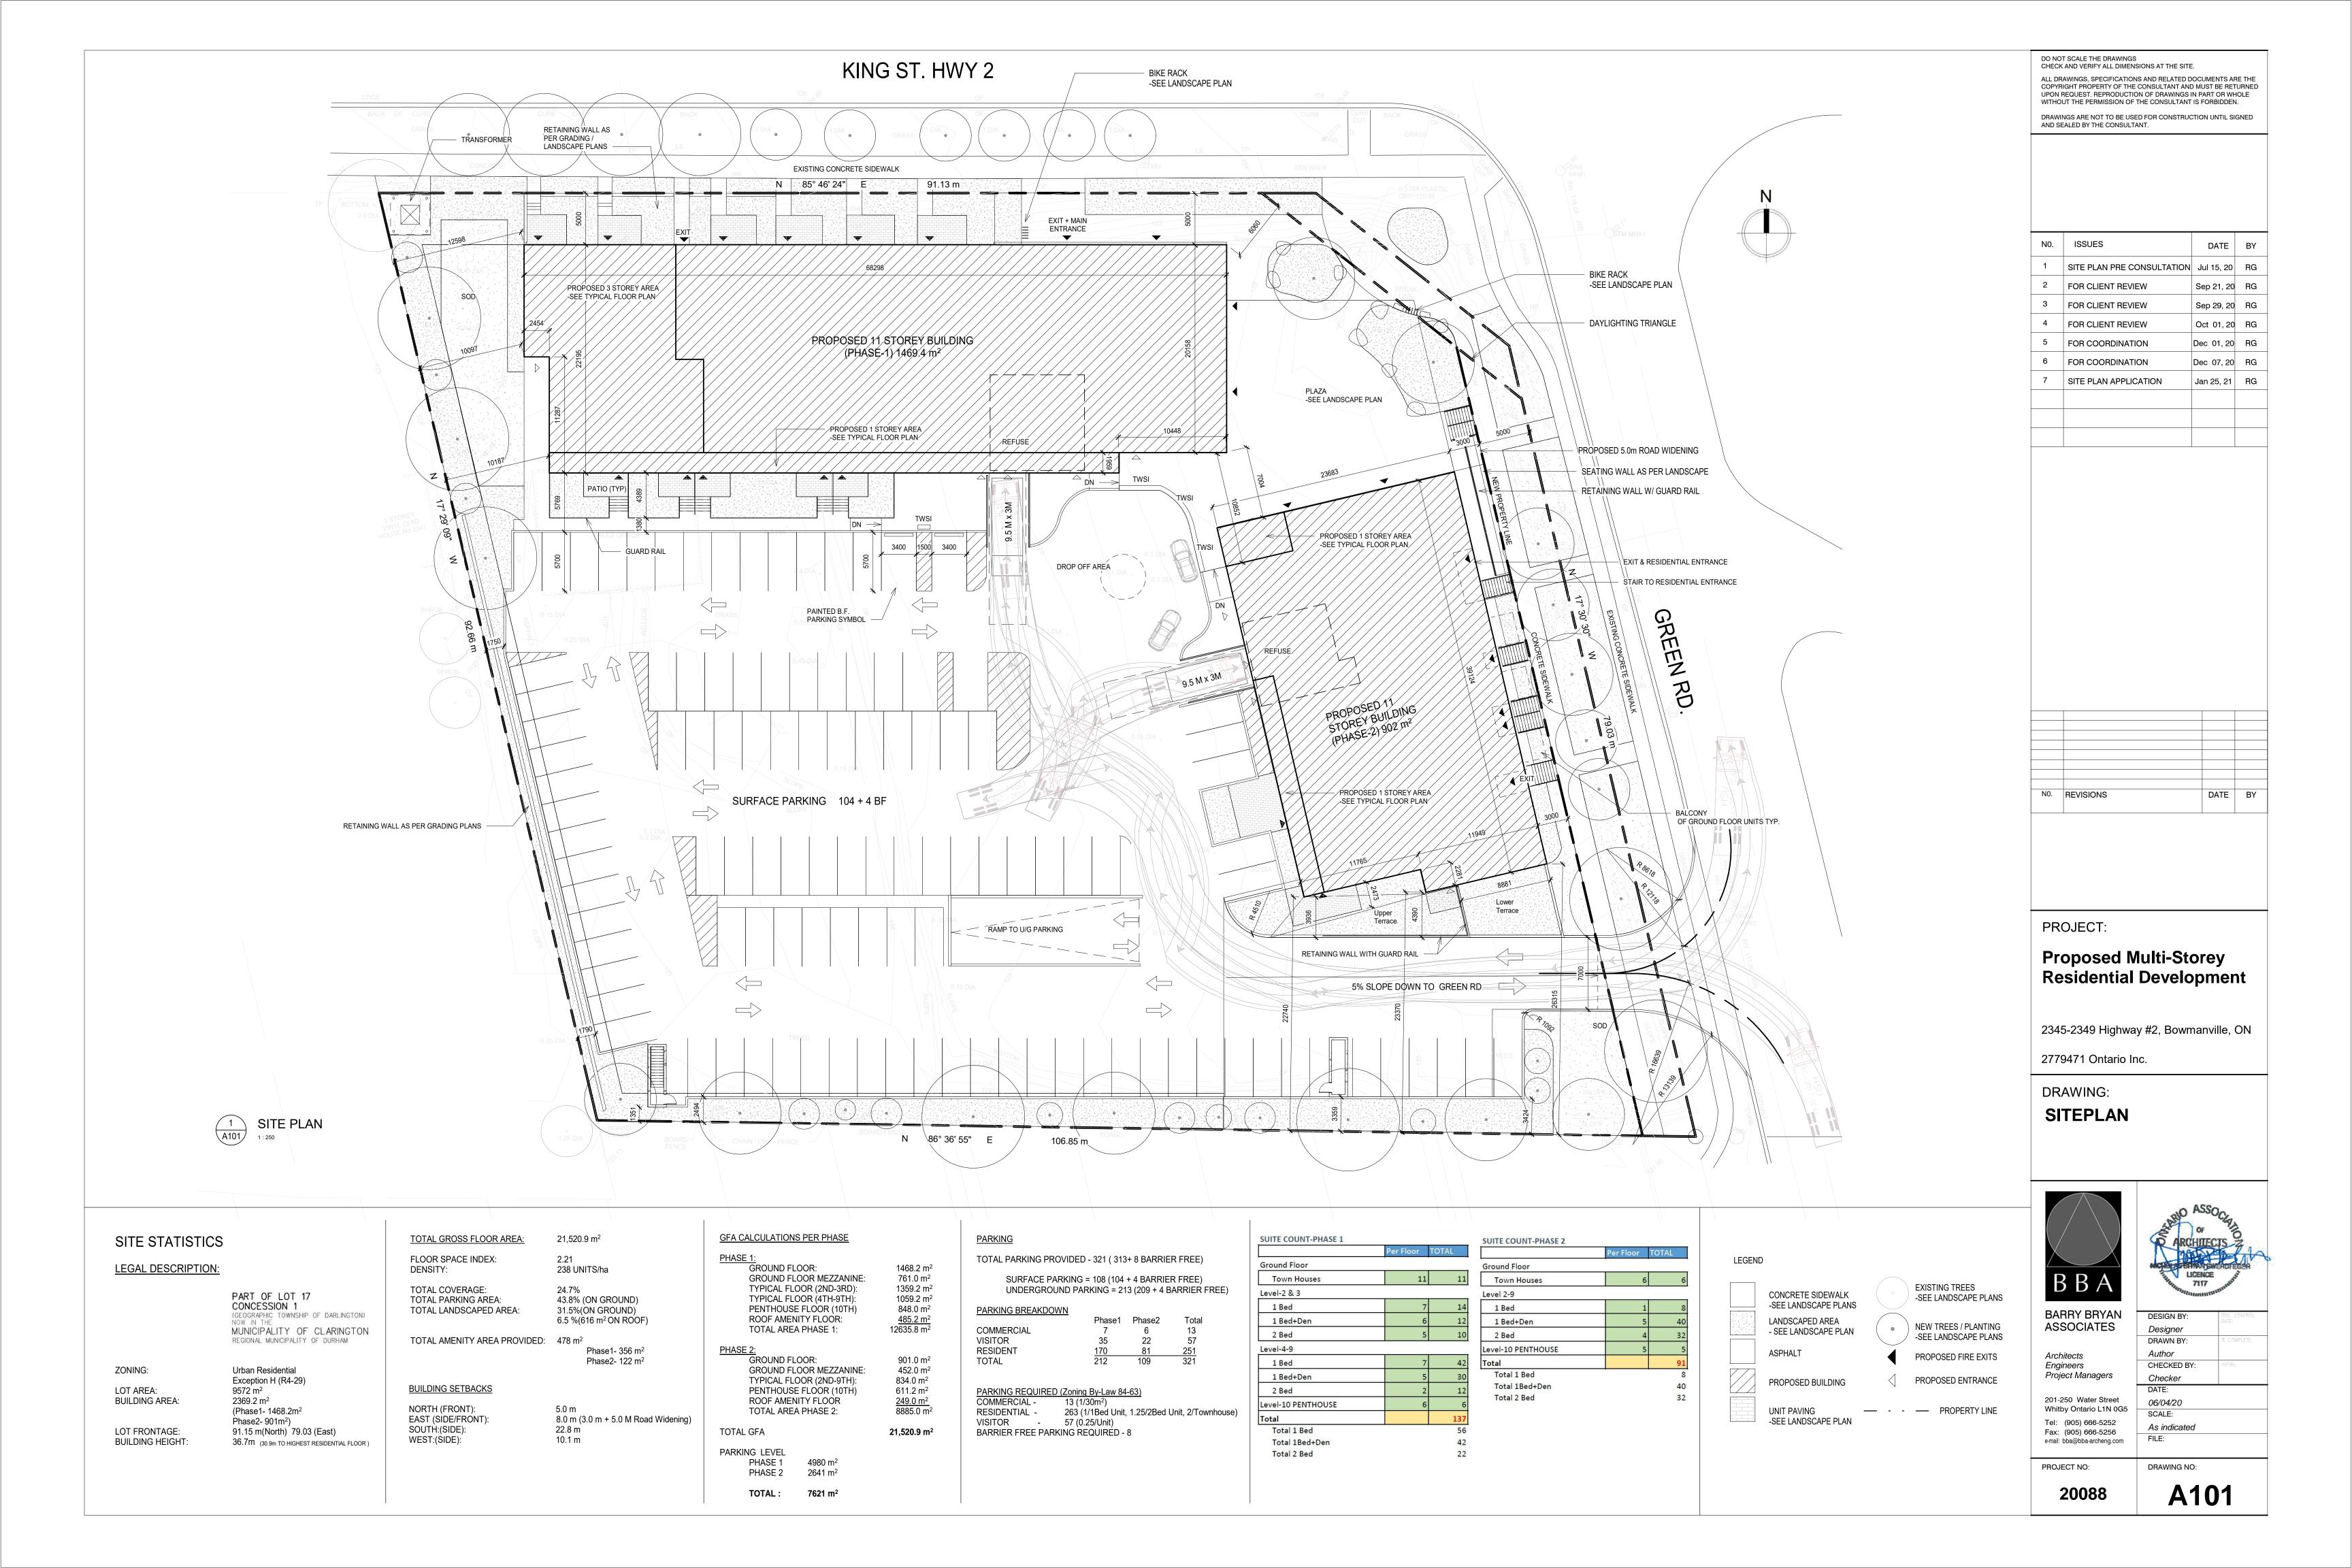
Proposed Multi-Residential Development 2345-2349 Highway #2, Bowmanville, ON


Drawing Title:

Landscape Details

20088

Designed By: TR Project #: Drawn By: TR Drawing #: Approved By: GB



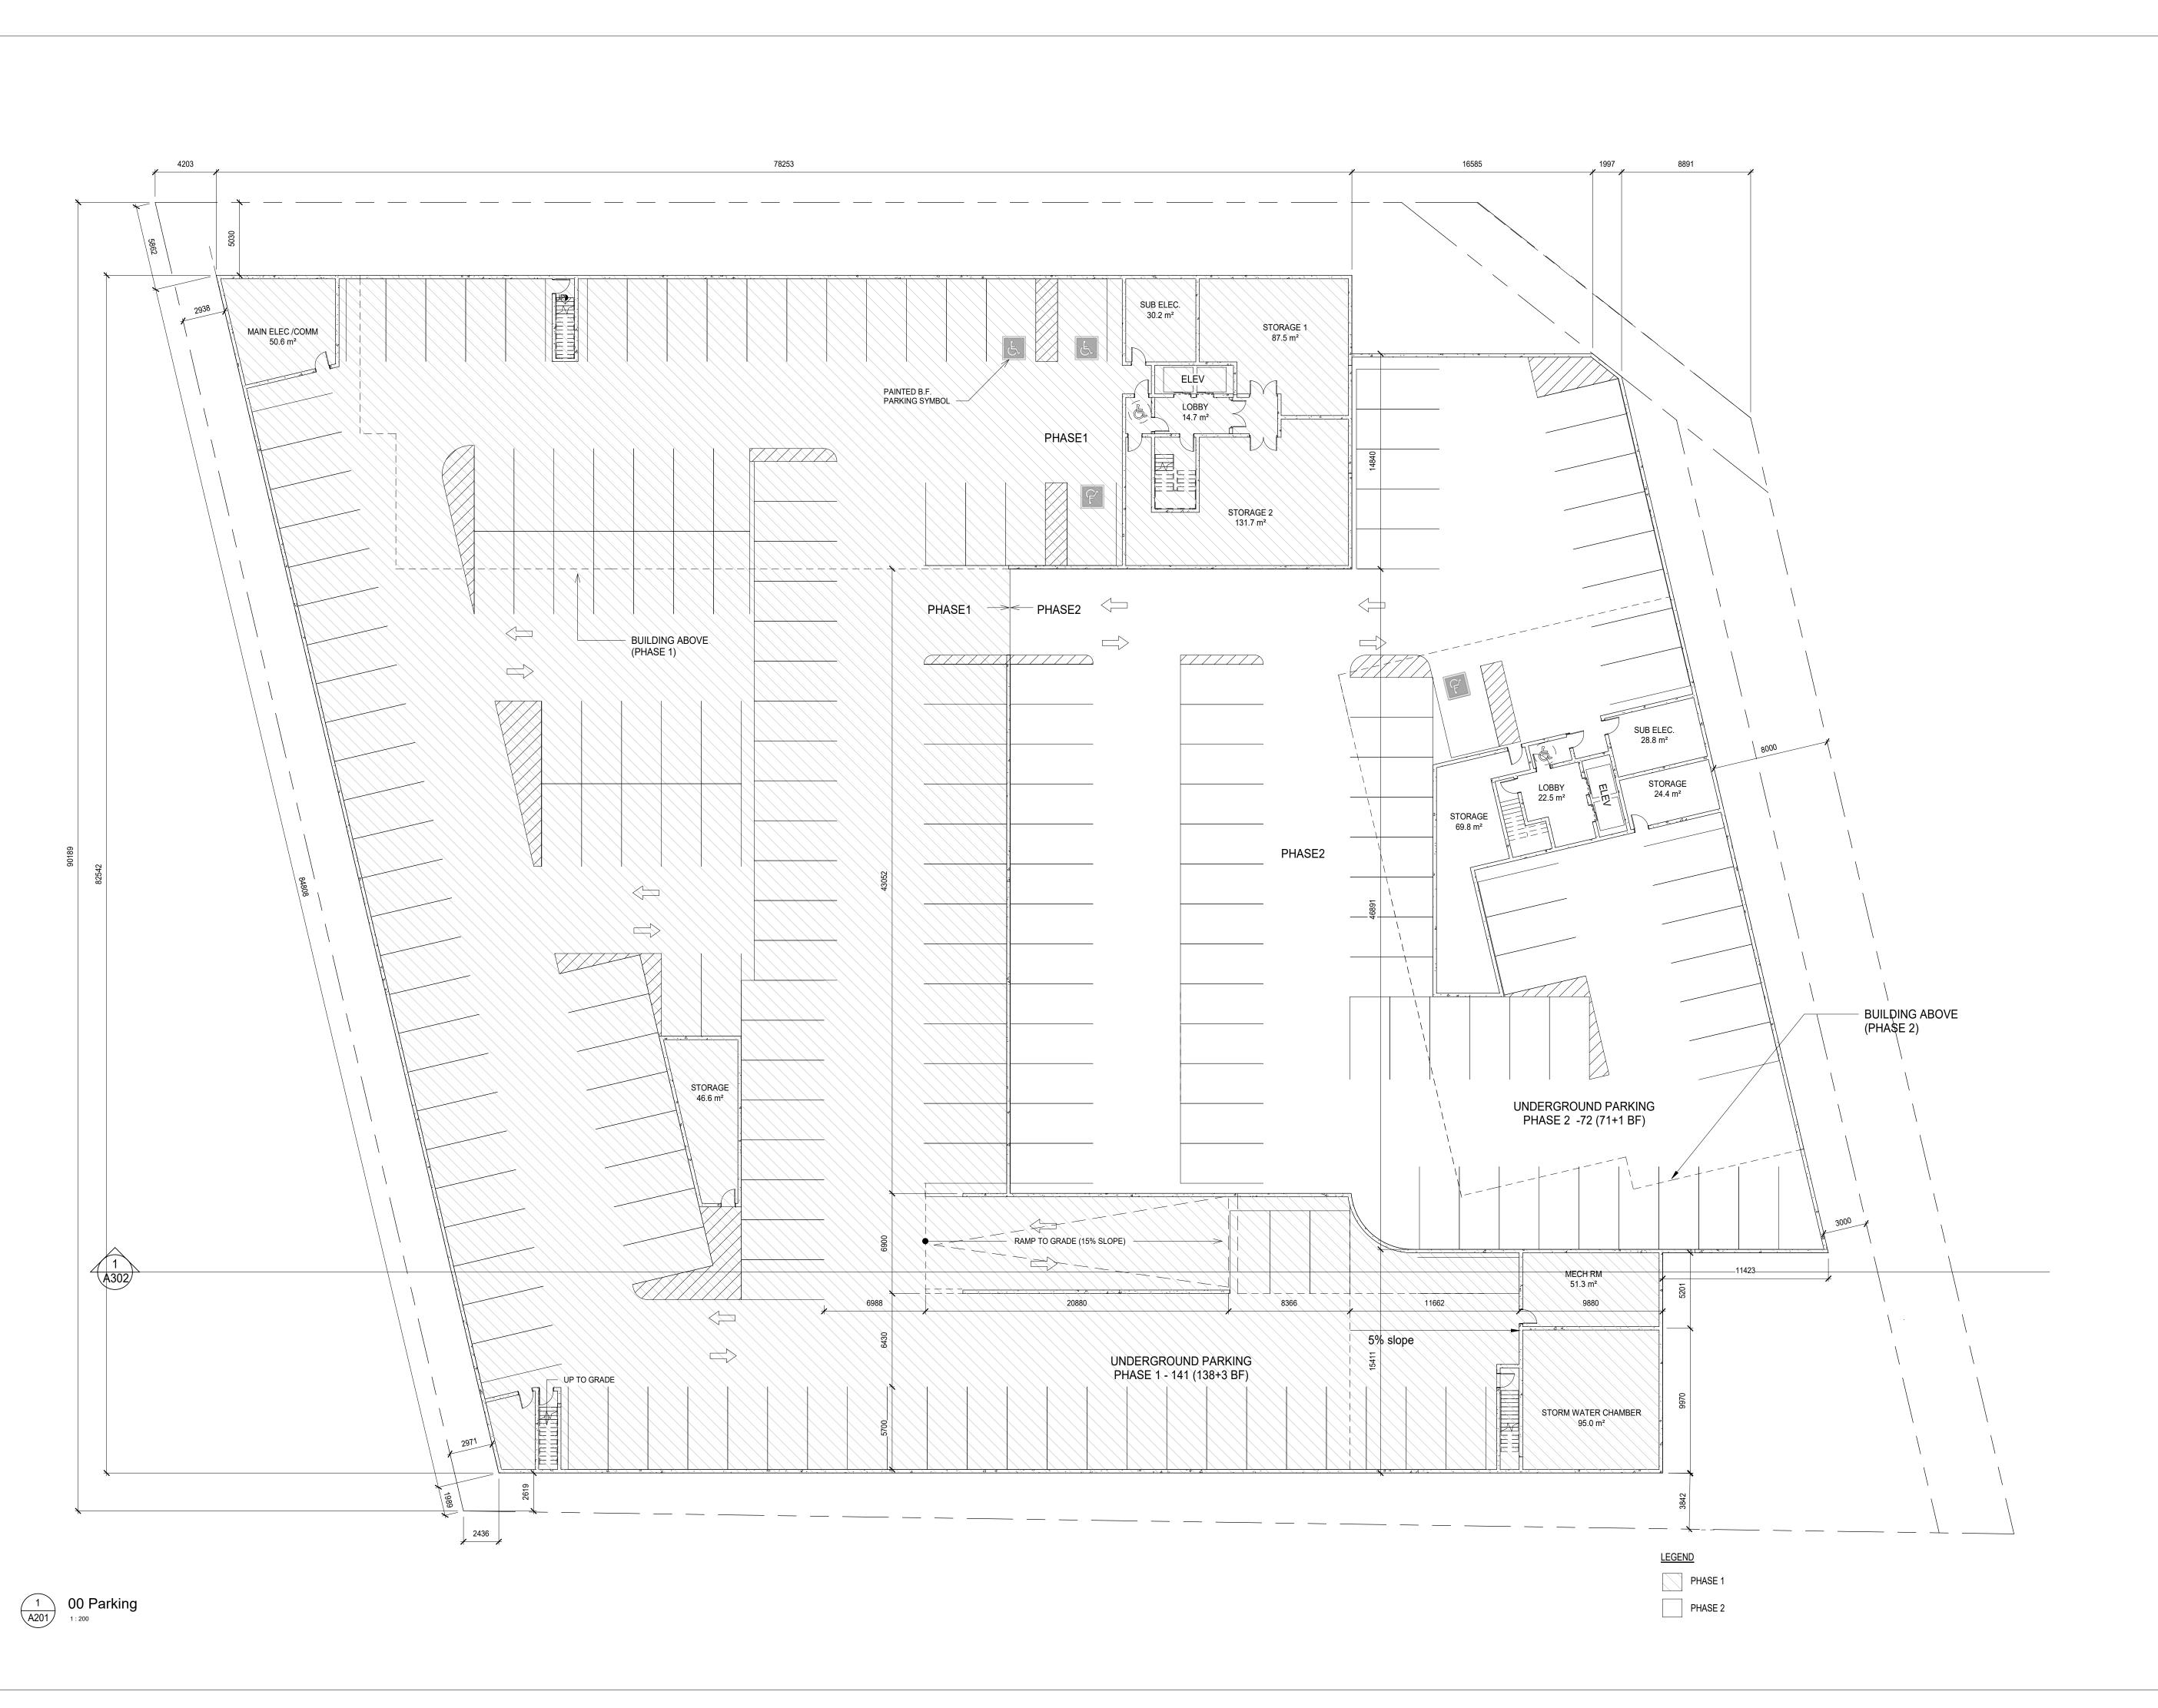

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5	FOR COORDINATION	Dec 01, 20	RG
6	FOR COORDINATION	Dec 07, 20	RG
7	SITE PLAN APPLICATION	Jan 25, 21	RG

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N0.	REVISIONS	DATE	

PROJECT:

## Proposed Multi-Storey Residential Development

2345-2349 Highway #2, Bowmanville, ON

2779471 Ontario Inc.

DRAWING:

#### PARKING FLOOR





BARRY BRYAN ASSOCIATES

DESIGN BY:

NS

DRAWN BY:

RG

CHECKED BY:

INITIAL:

S

DATE:


Architects
Engineers
Project Managers

201-250 Water Street
Whitby Ontario L1N 0G5
Tel: (905) 666-5252
Fax: (905) 666-5256
e-mail: bba@bba-archeng.com

G5 13/04/20 SCALE: 1:200 FILE:

DRAWING NO:

PROJECT NO: **20088** 

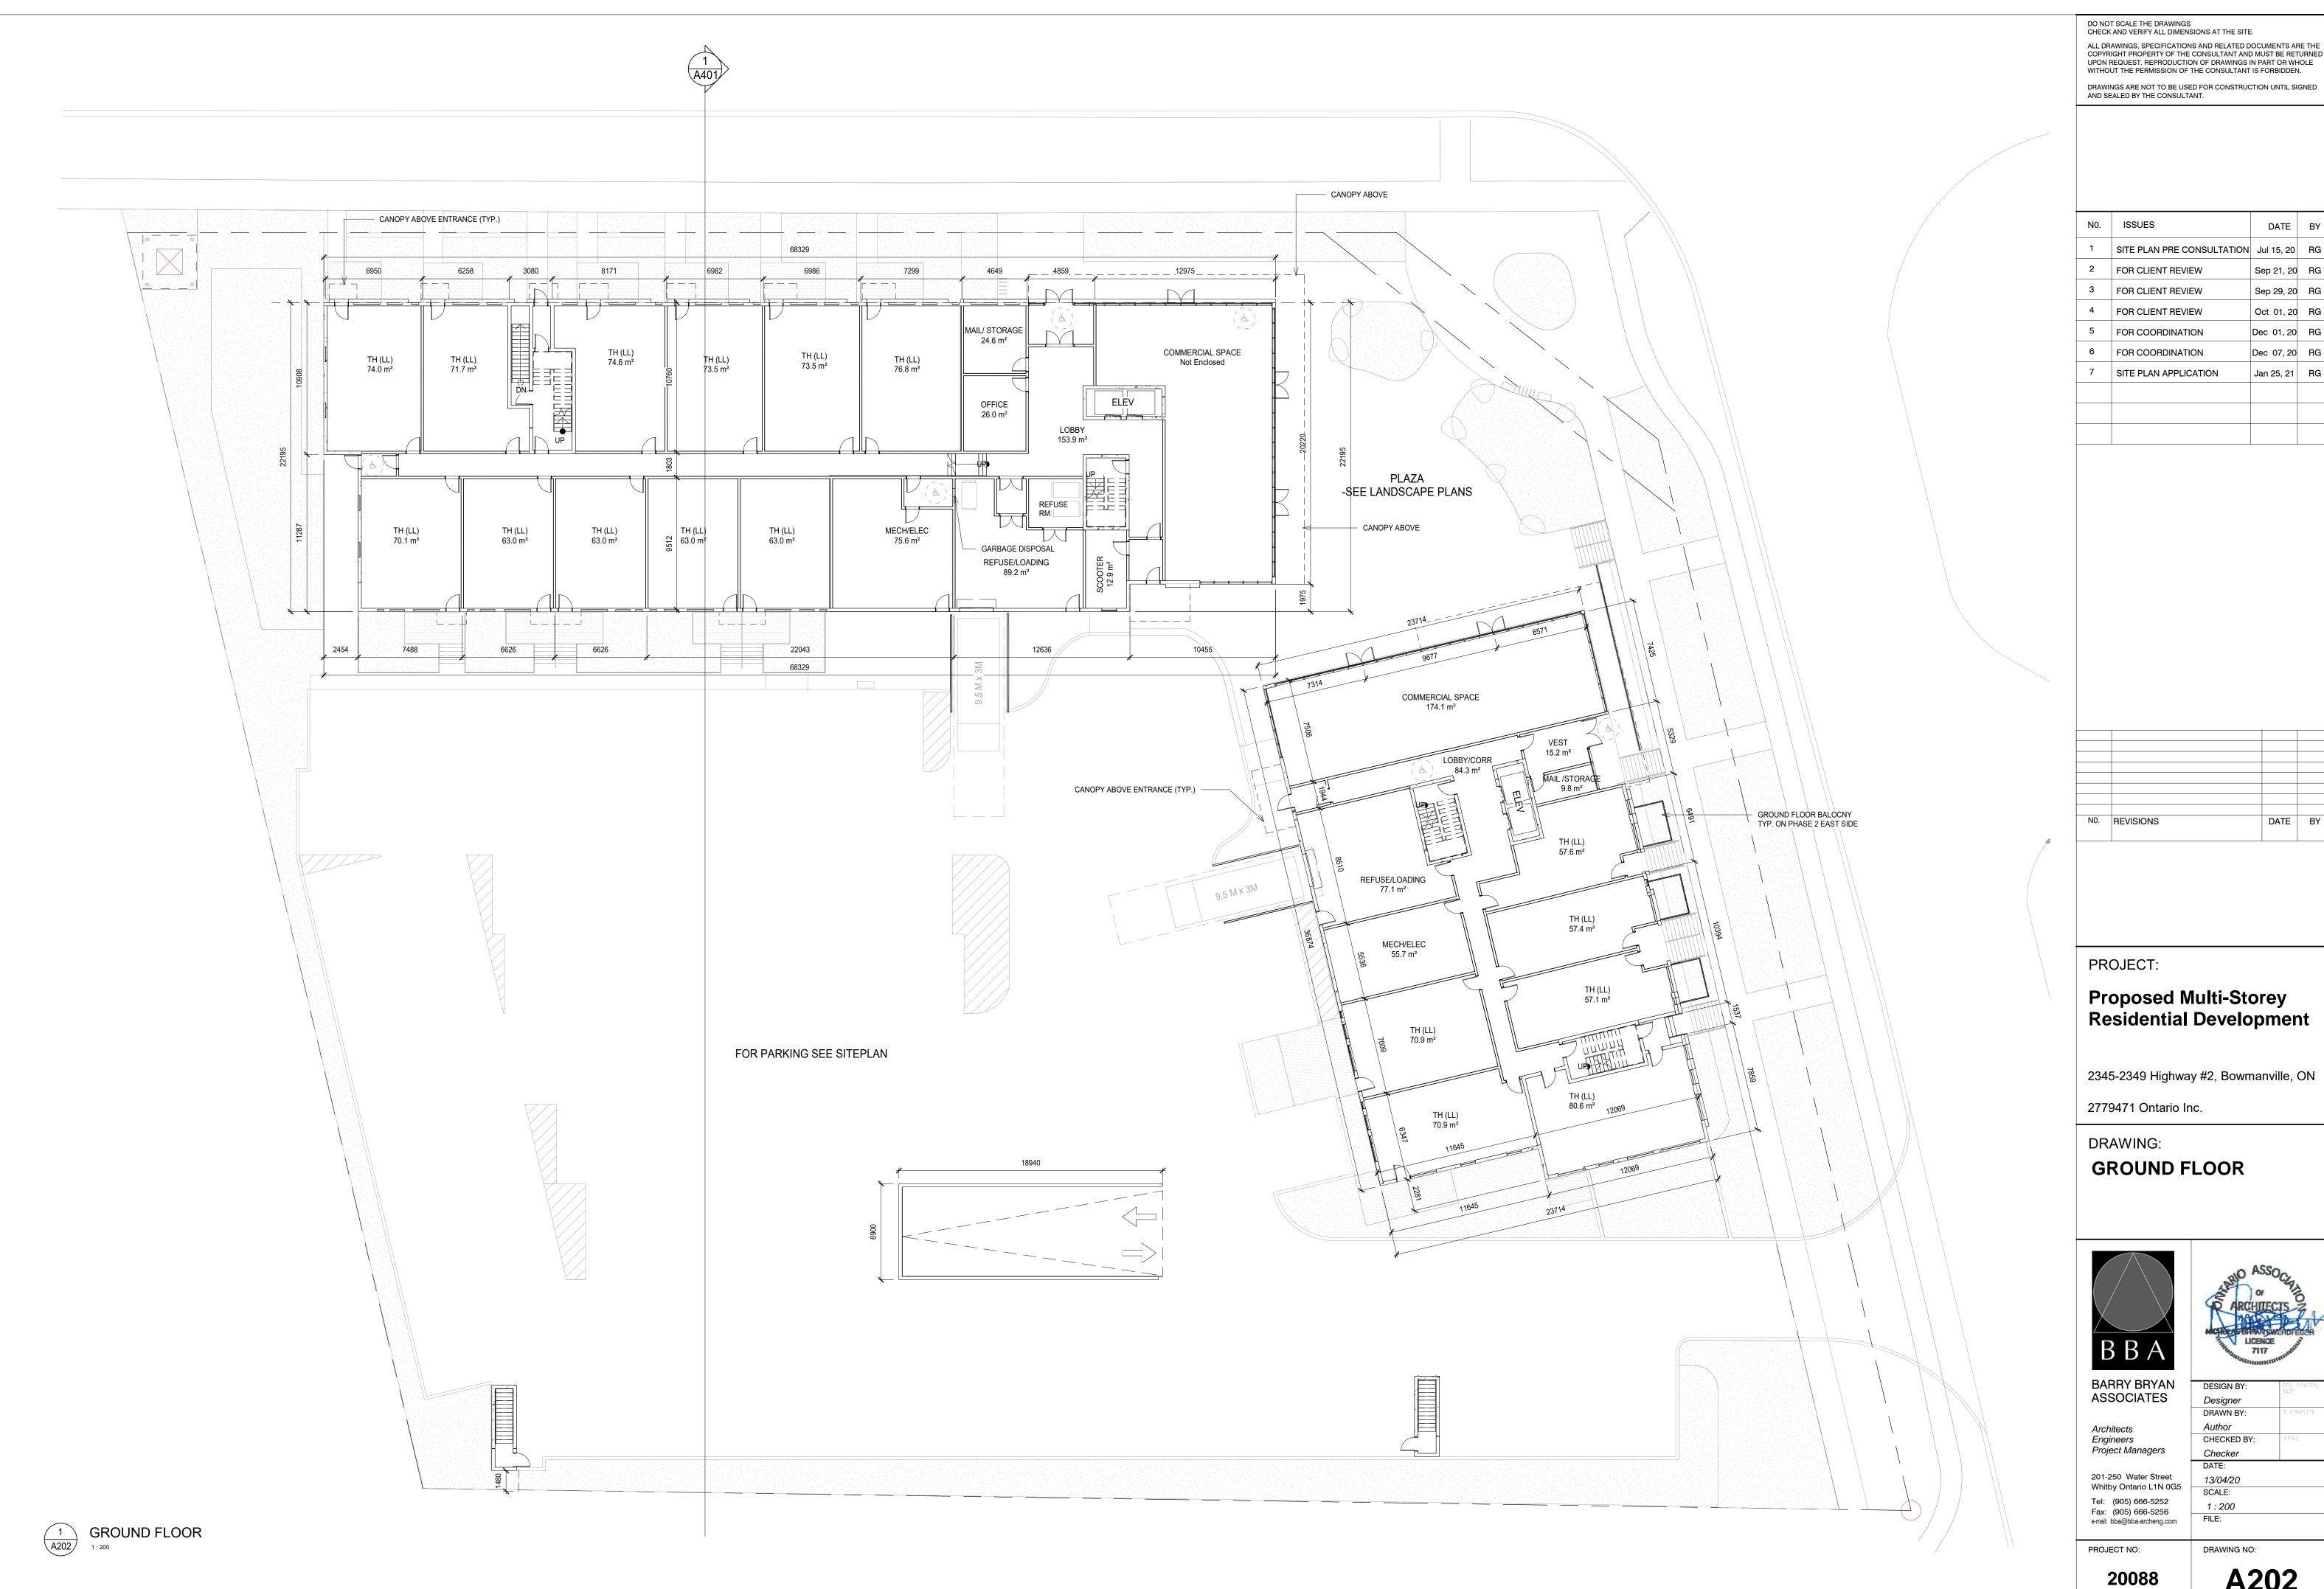

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	7	SITE PLAN APPLICATION	Jan 25, 21	RG
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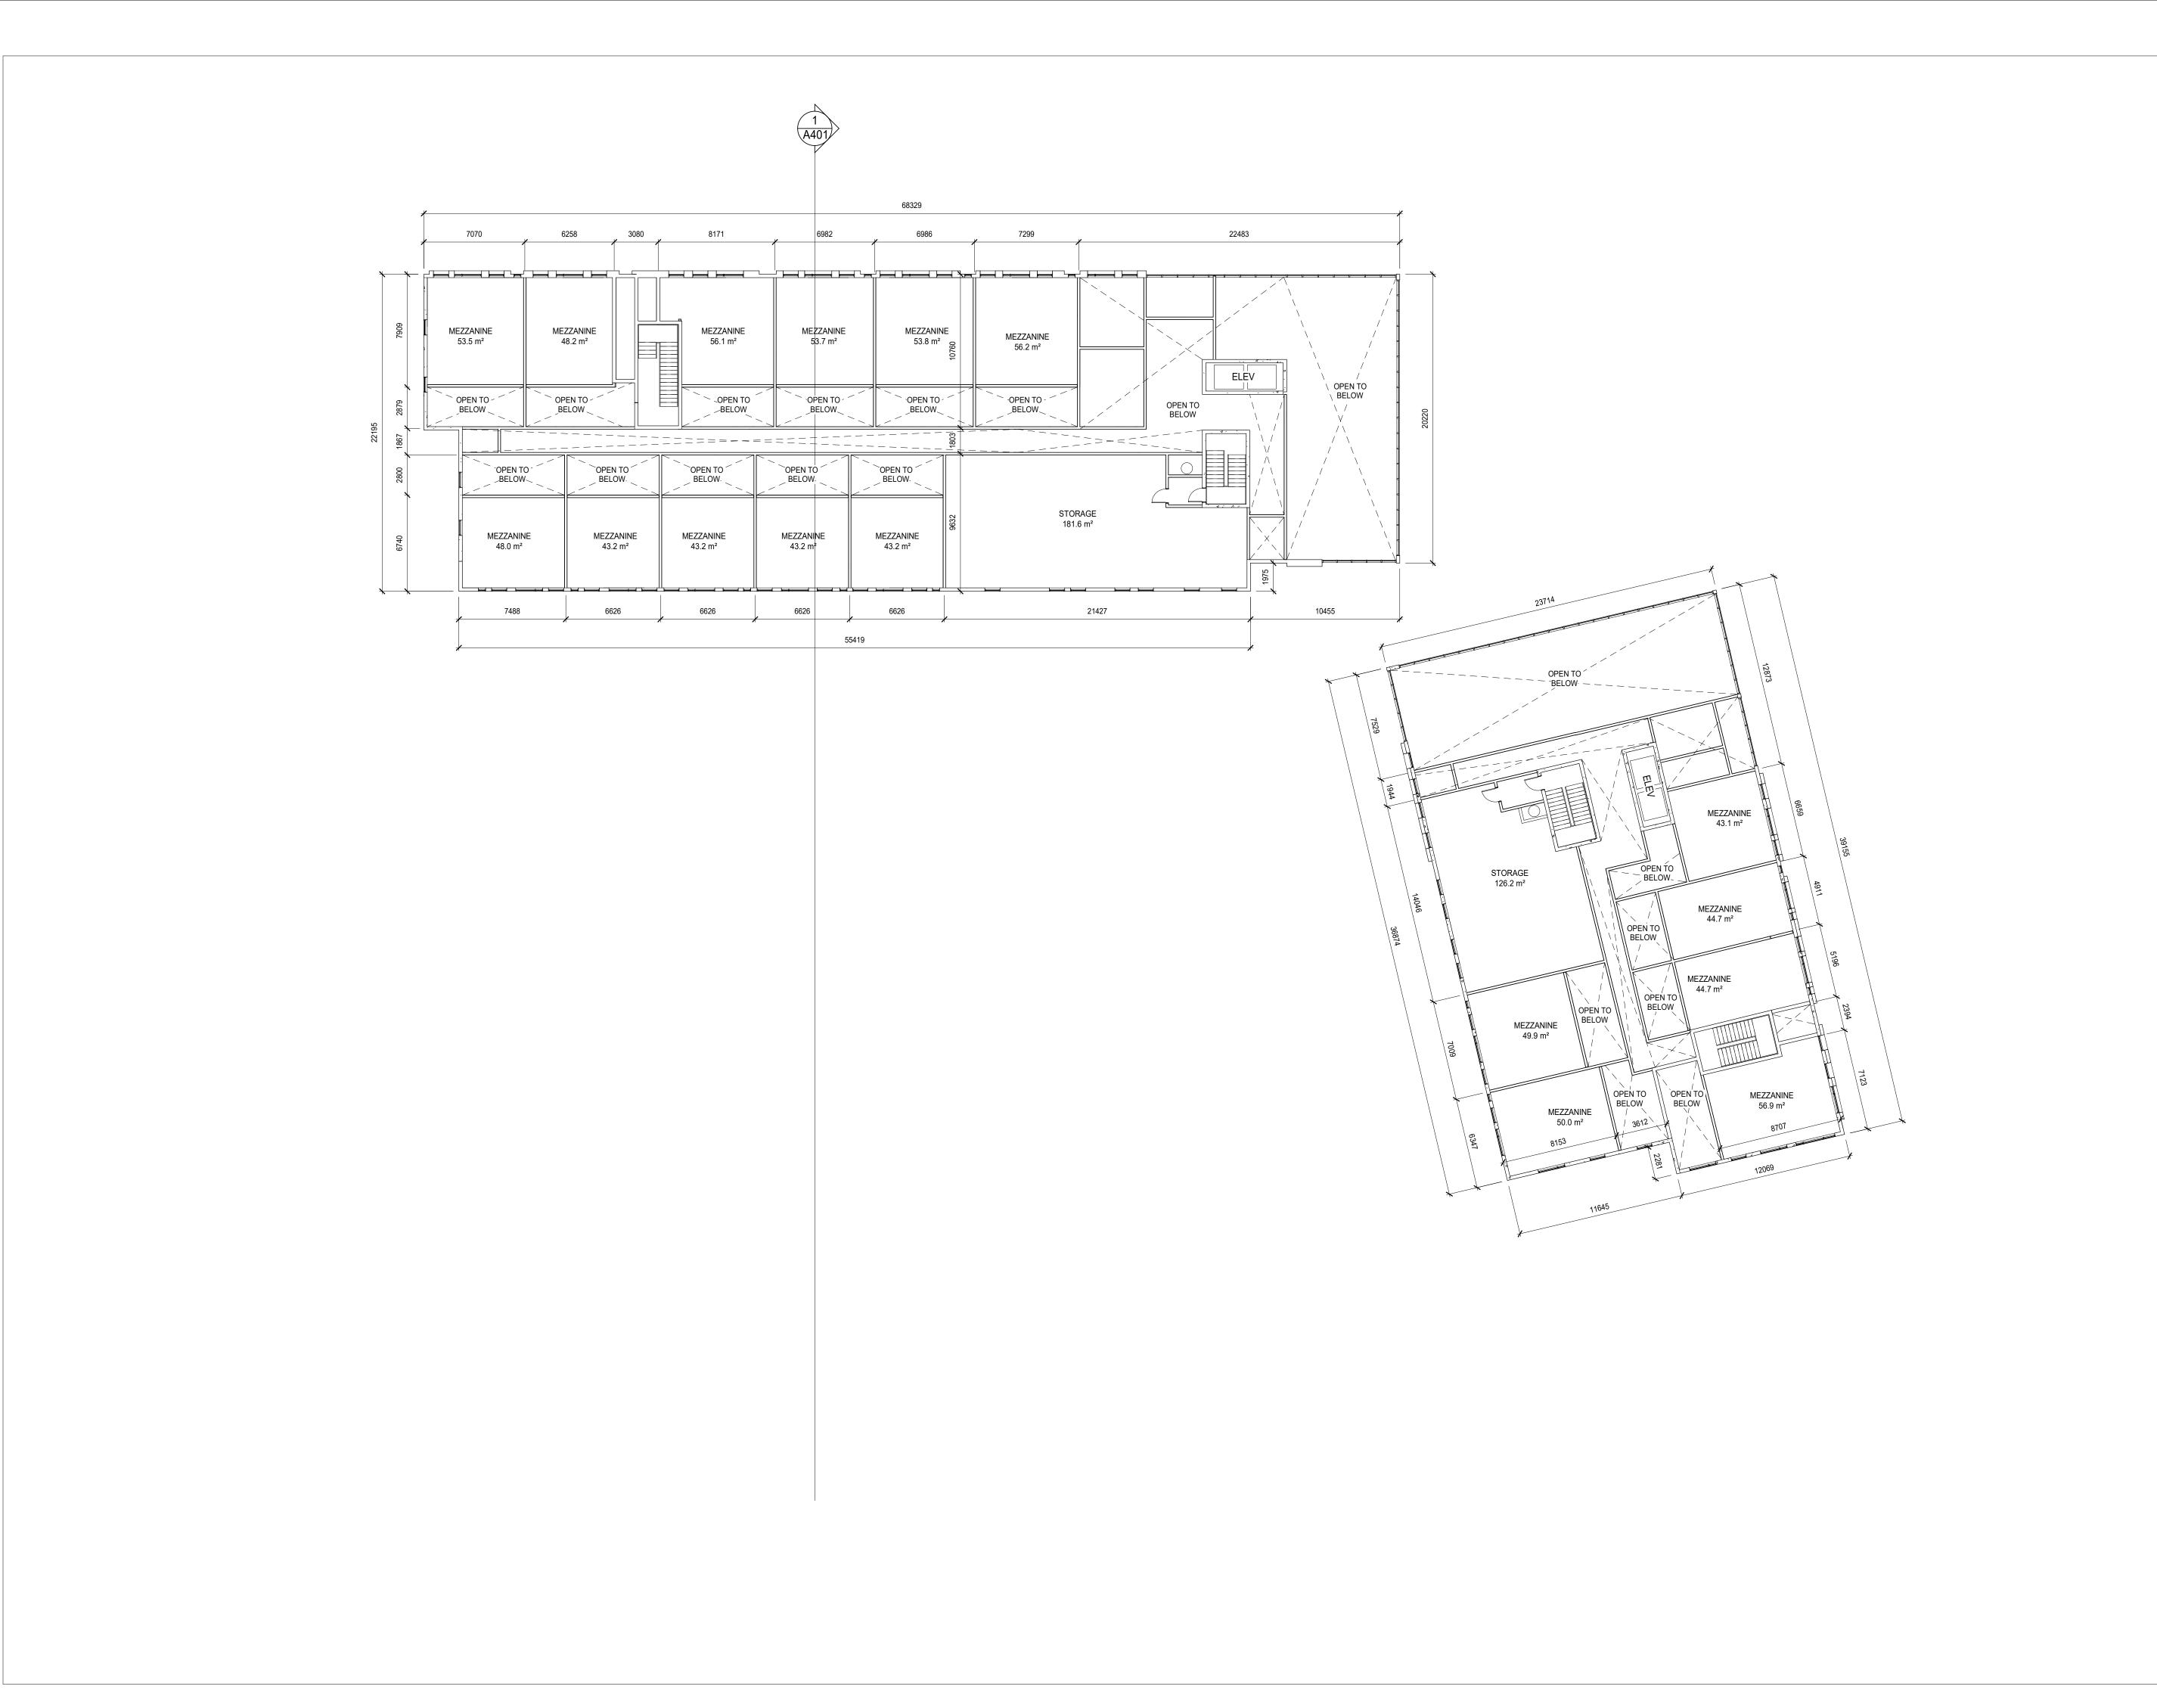
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#### **Proposed Multi-Storey** Residential Development

2345-2349 Highway #2, Bowmanville, ON



CHECKED BY:



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PROJECT:

## **Proposed Multi-Storey** Residential Development

2345-2349 Highway #2, Bowmanville, ON

2779471 Ontario Inc.

DRAWING:

#### **MEZZANINE**



BARRY BRYA
ASSOCIATES

Architects Engineers Project Managers

201-250 Water Street Whitby Ontario L1N 0G5 Tel: (905) 666-5252 Fax: (905) 666-5256 e-mail: bba@bba-archeng.com

CHECKED BY: 09/30/20 1:200


Designer
DRAWN BY:

Author

PROJECT NO: 20088

DRAWING NO: **A203** 

FILE:

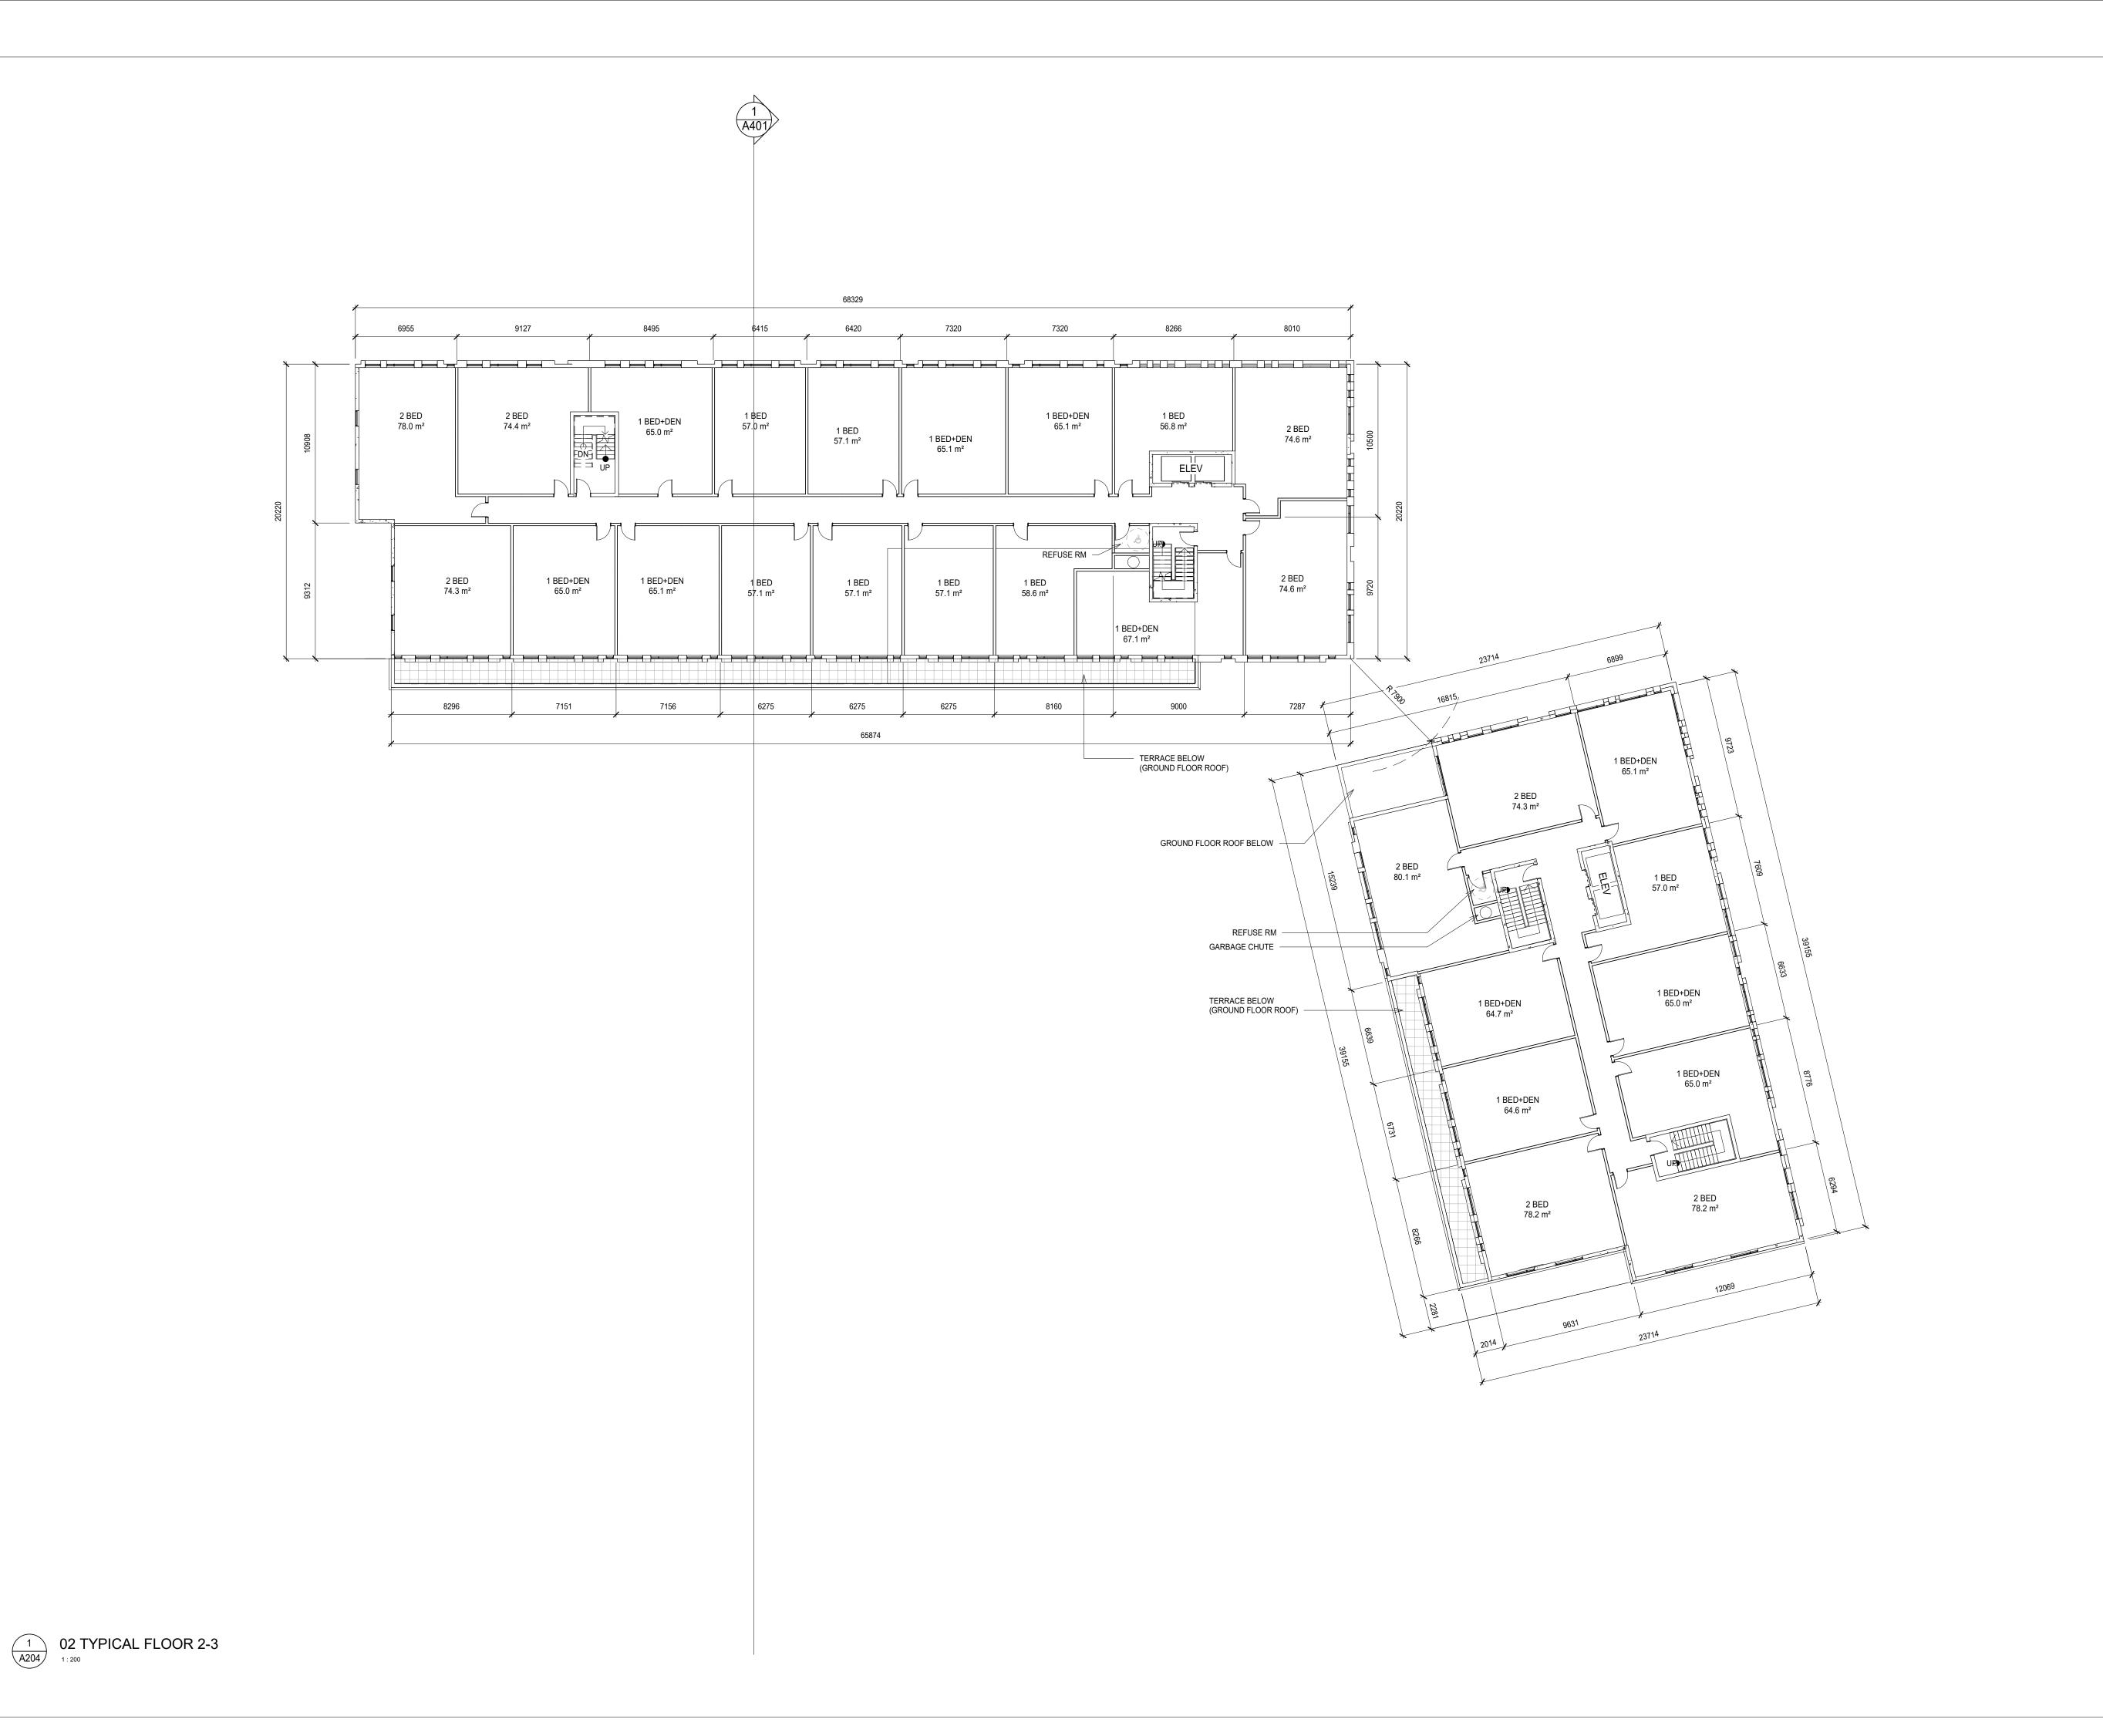

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6	FOR COORDINATION	Dec 07, 20	RG
7	SITE PLAN APPLICATION	Jan 25, 21	RG

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PROJECT:

#### Proposed Multi-Storey Residential Development

2345-2349 Highway #2, Bowmanville, ON

2779471 Ontario Inc.

#### DRAWING:

#### **TYPICAL FLOOR 2-3**





BARRY BRYA
ASSOCIATES

Architects
Engineers
Project Managers

Engineers
Project Managers


201-250 Water Street
Whitby Ontario L1N 0G5

Tel: (905) 666-5252
Fax: (905) 666-5256
e-mail: bba@bba-archeng.com

Designer	
DRAWN BY:	% COMPLETE:
Author	
CHECKED BY:	INITIAL:
Checker	
DATE:	
13/04/20	
SCALE:	
1:200	

DRAWING NO:

PROJECT NO:

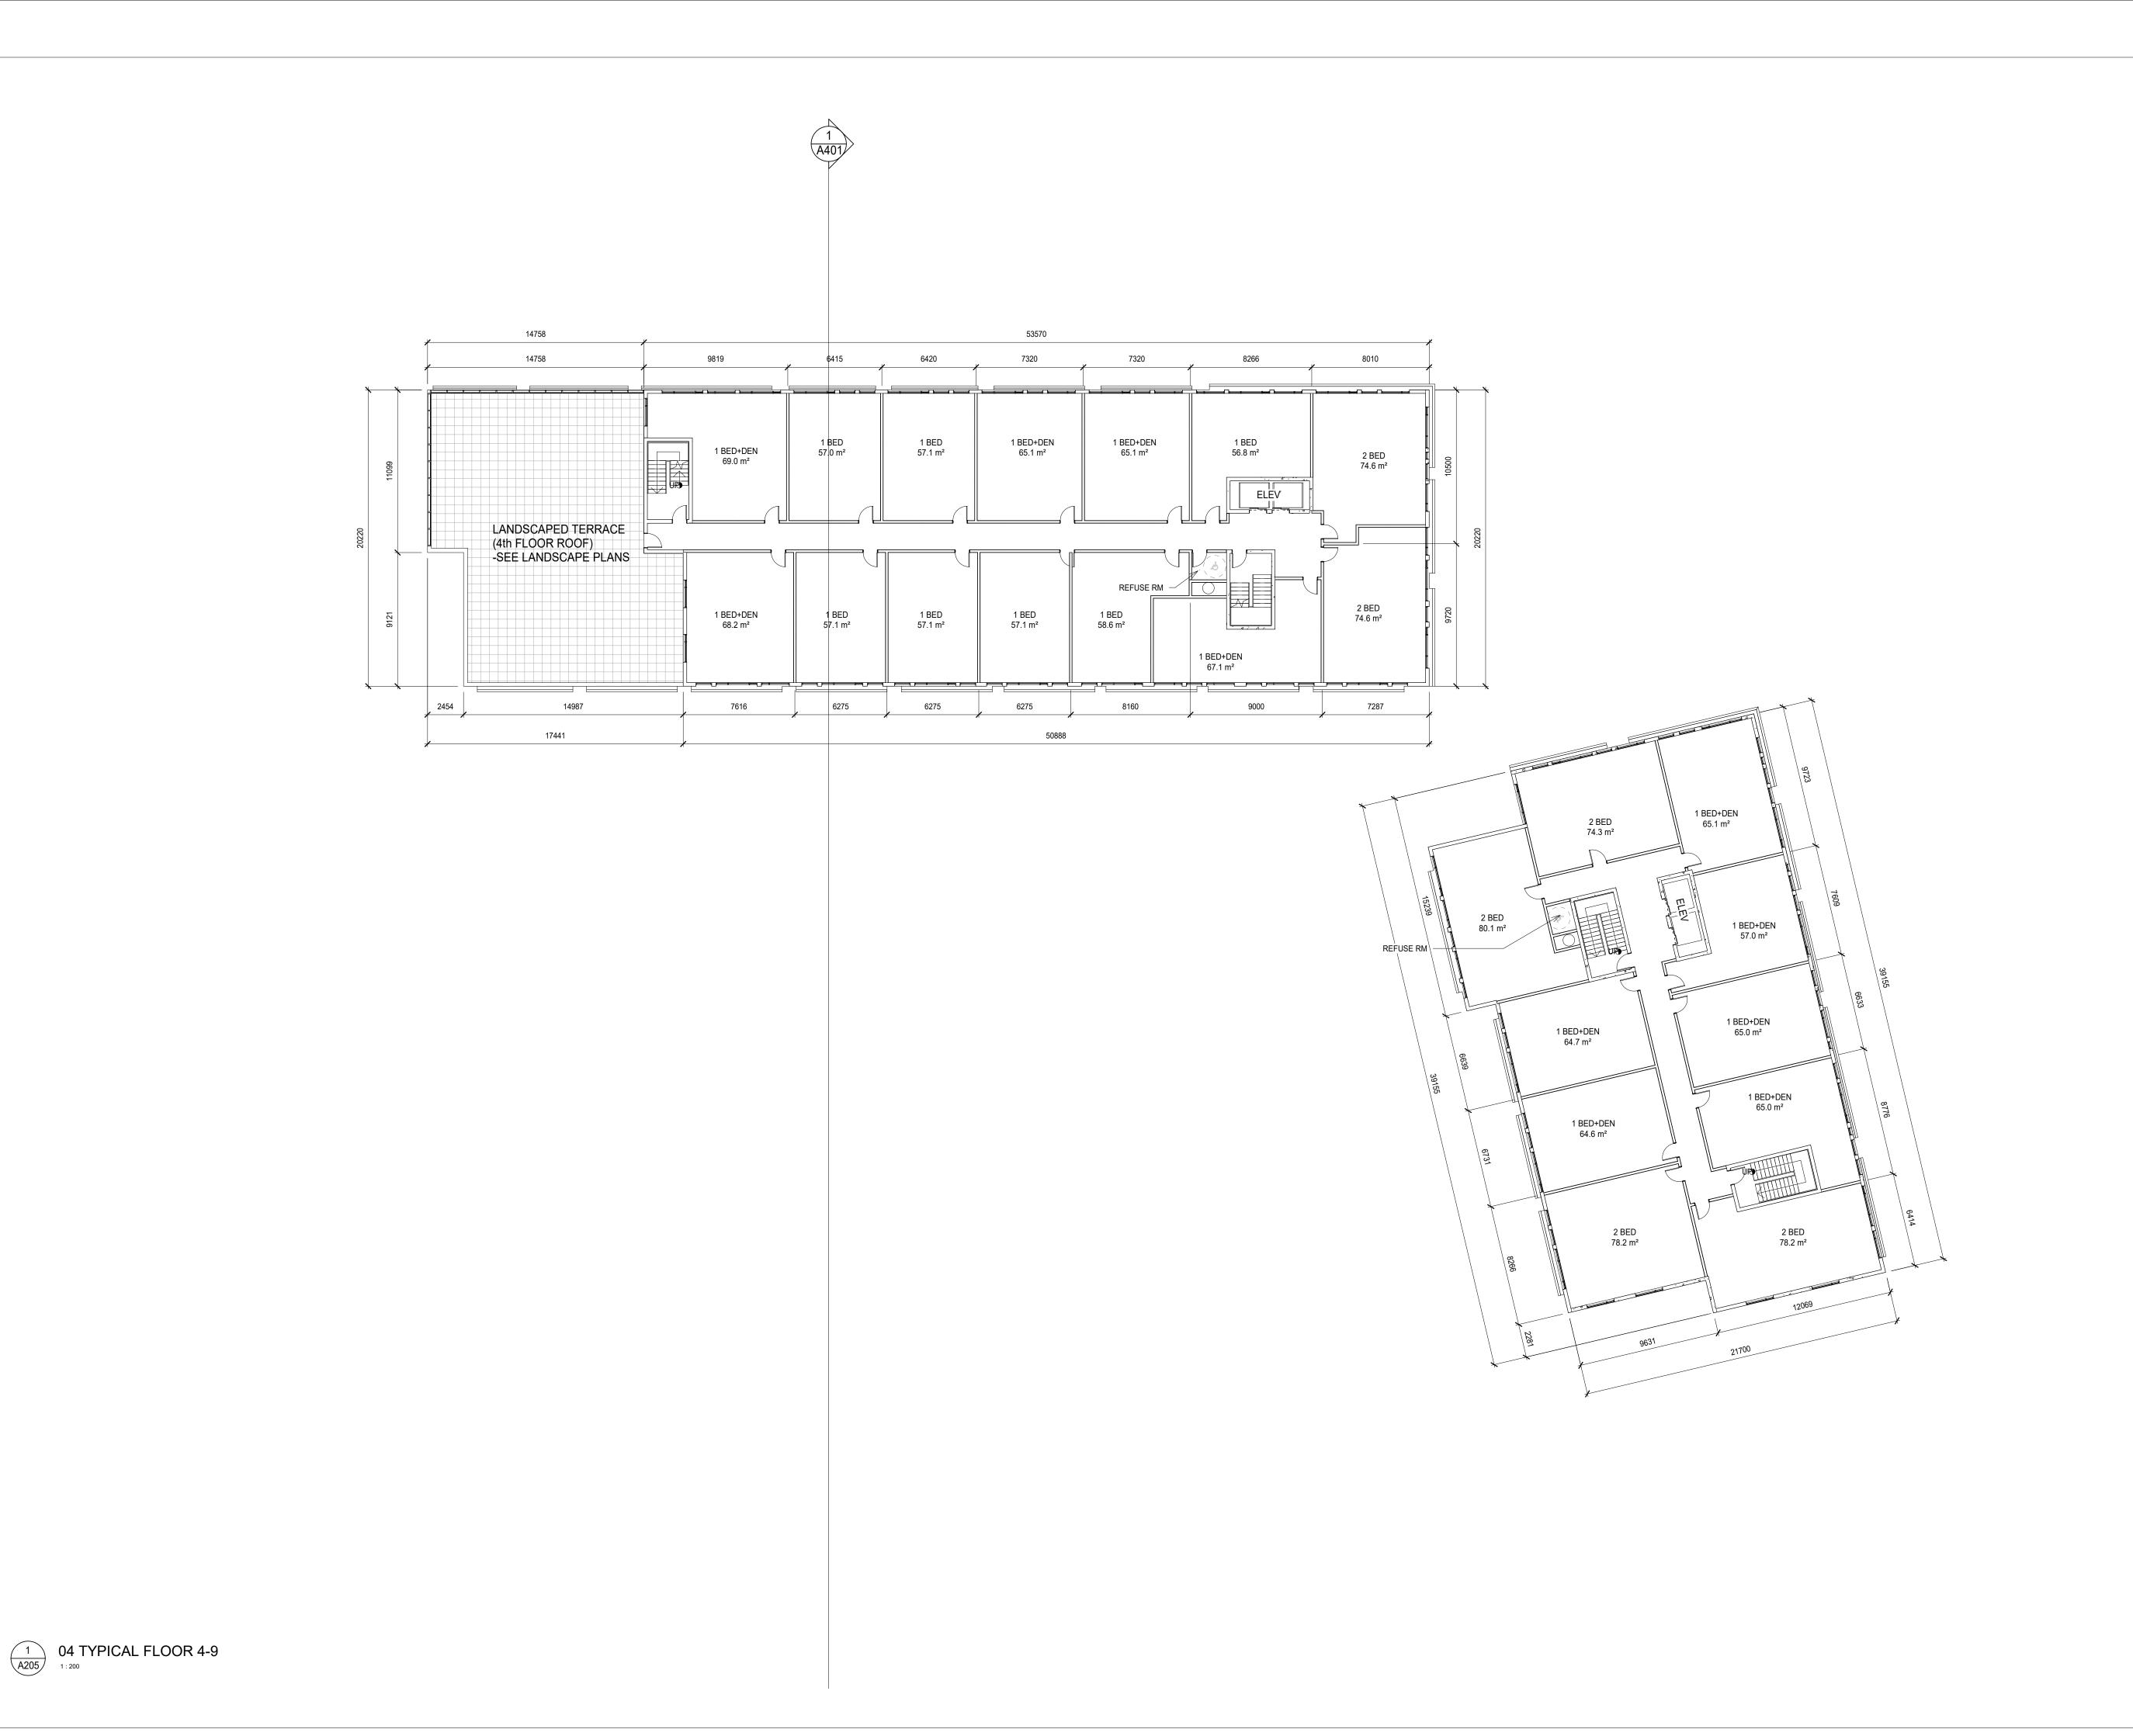

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7	SITE PLAN APPLICATION	Jan 25, 21	RG
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N0.	REVISIONS	DATE	B۱

PROJECT:

#### Proposed Multi-Storey Residential Development

2345-2349 Highway #2, Bowmanville, ON

2779471 Ontario Inc.

DRAWING:

**TYPICAL FLOOR 4-9** 





BARRY BRYAN ASSOCIATES

DESIGN BY:
Designer
DRAWN BY:
Author
CHECKED BY:
Checker
DATE:
OCCATOR

Architects
Engineers
Project Managers

201-250 Water Street
Whitby Ontario L1N 0G5
Tel: (905) 666-5252
Fax: (905) 666-5256
e-mail: bba@bba-archeng.com


DATE: 06/04/20 SCALE: 1:200 FILE:

PROJECT NO: **20088** 

A205

DRAWING NO:



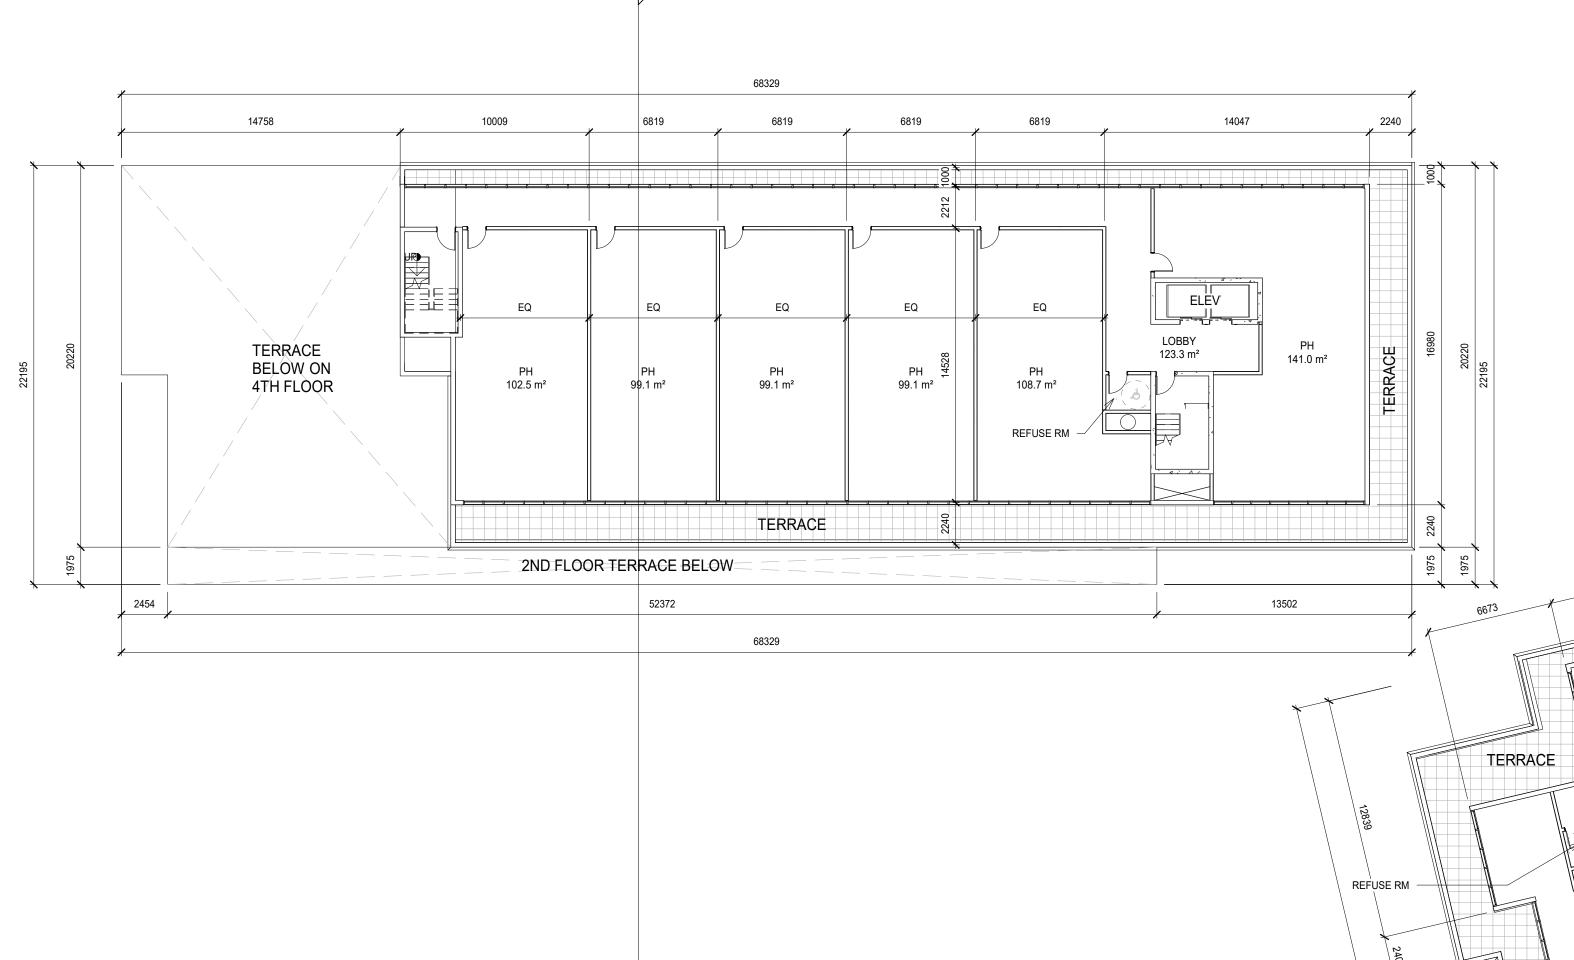

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7	SITE PLAN APPLICATION	Jan 25, 21	RG

N0.	REVISIONS	DATE	BY

#### PROJECT:

82.8 m<sup>2</sup>

PH 90.8 m²

## **Proposed Multi-Storey** Residential Development

2345-2349 Highway #2, Bowmanville, ON

2779471 Ontario Inc.

#### DRAWING:

#### PENTHOUSE FLOOR -10



OF ARCHITECTS OF
--

BARRY BRYAN ASSOCIATES
Architects Engineers Project Managers

CHECKED BY: 201-250 Water Street Whitby Ontario L1N 0G5 06/04/20

Designer DRAWN BY:


Author

Tel: (905) 666-5252 Fax: (905) 666-5256 e-mail: bba@bba-archeng.com 1:200 FILE:

DRAWING NO:

PROJECT NO: 20088



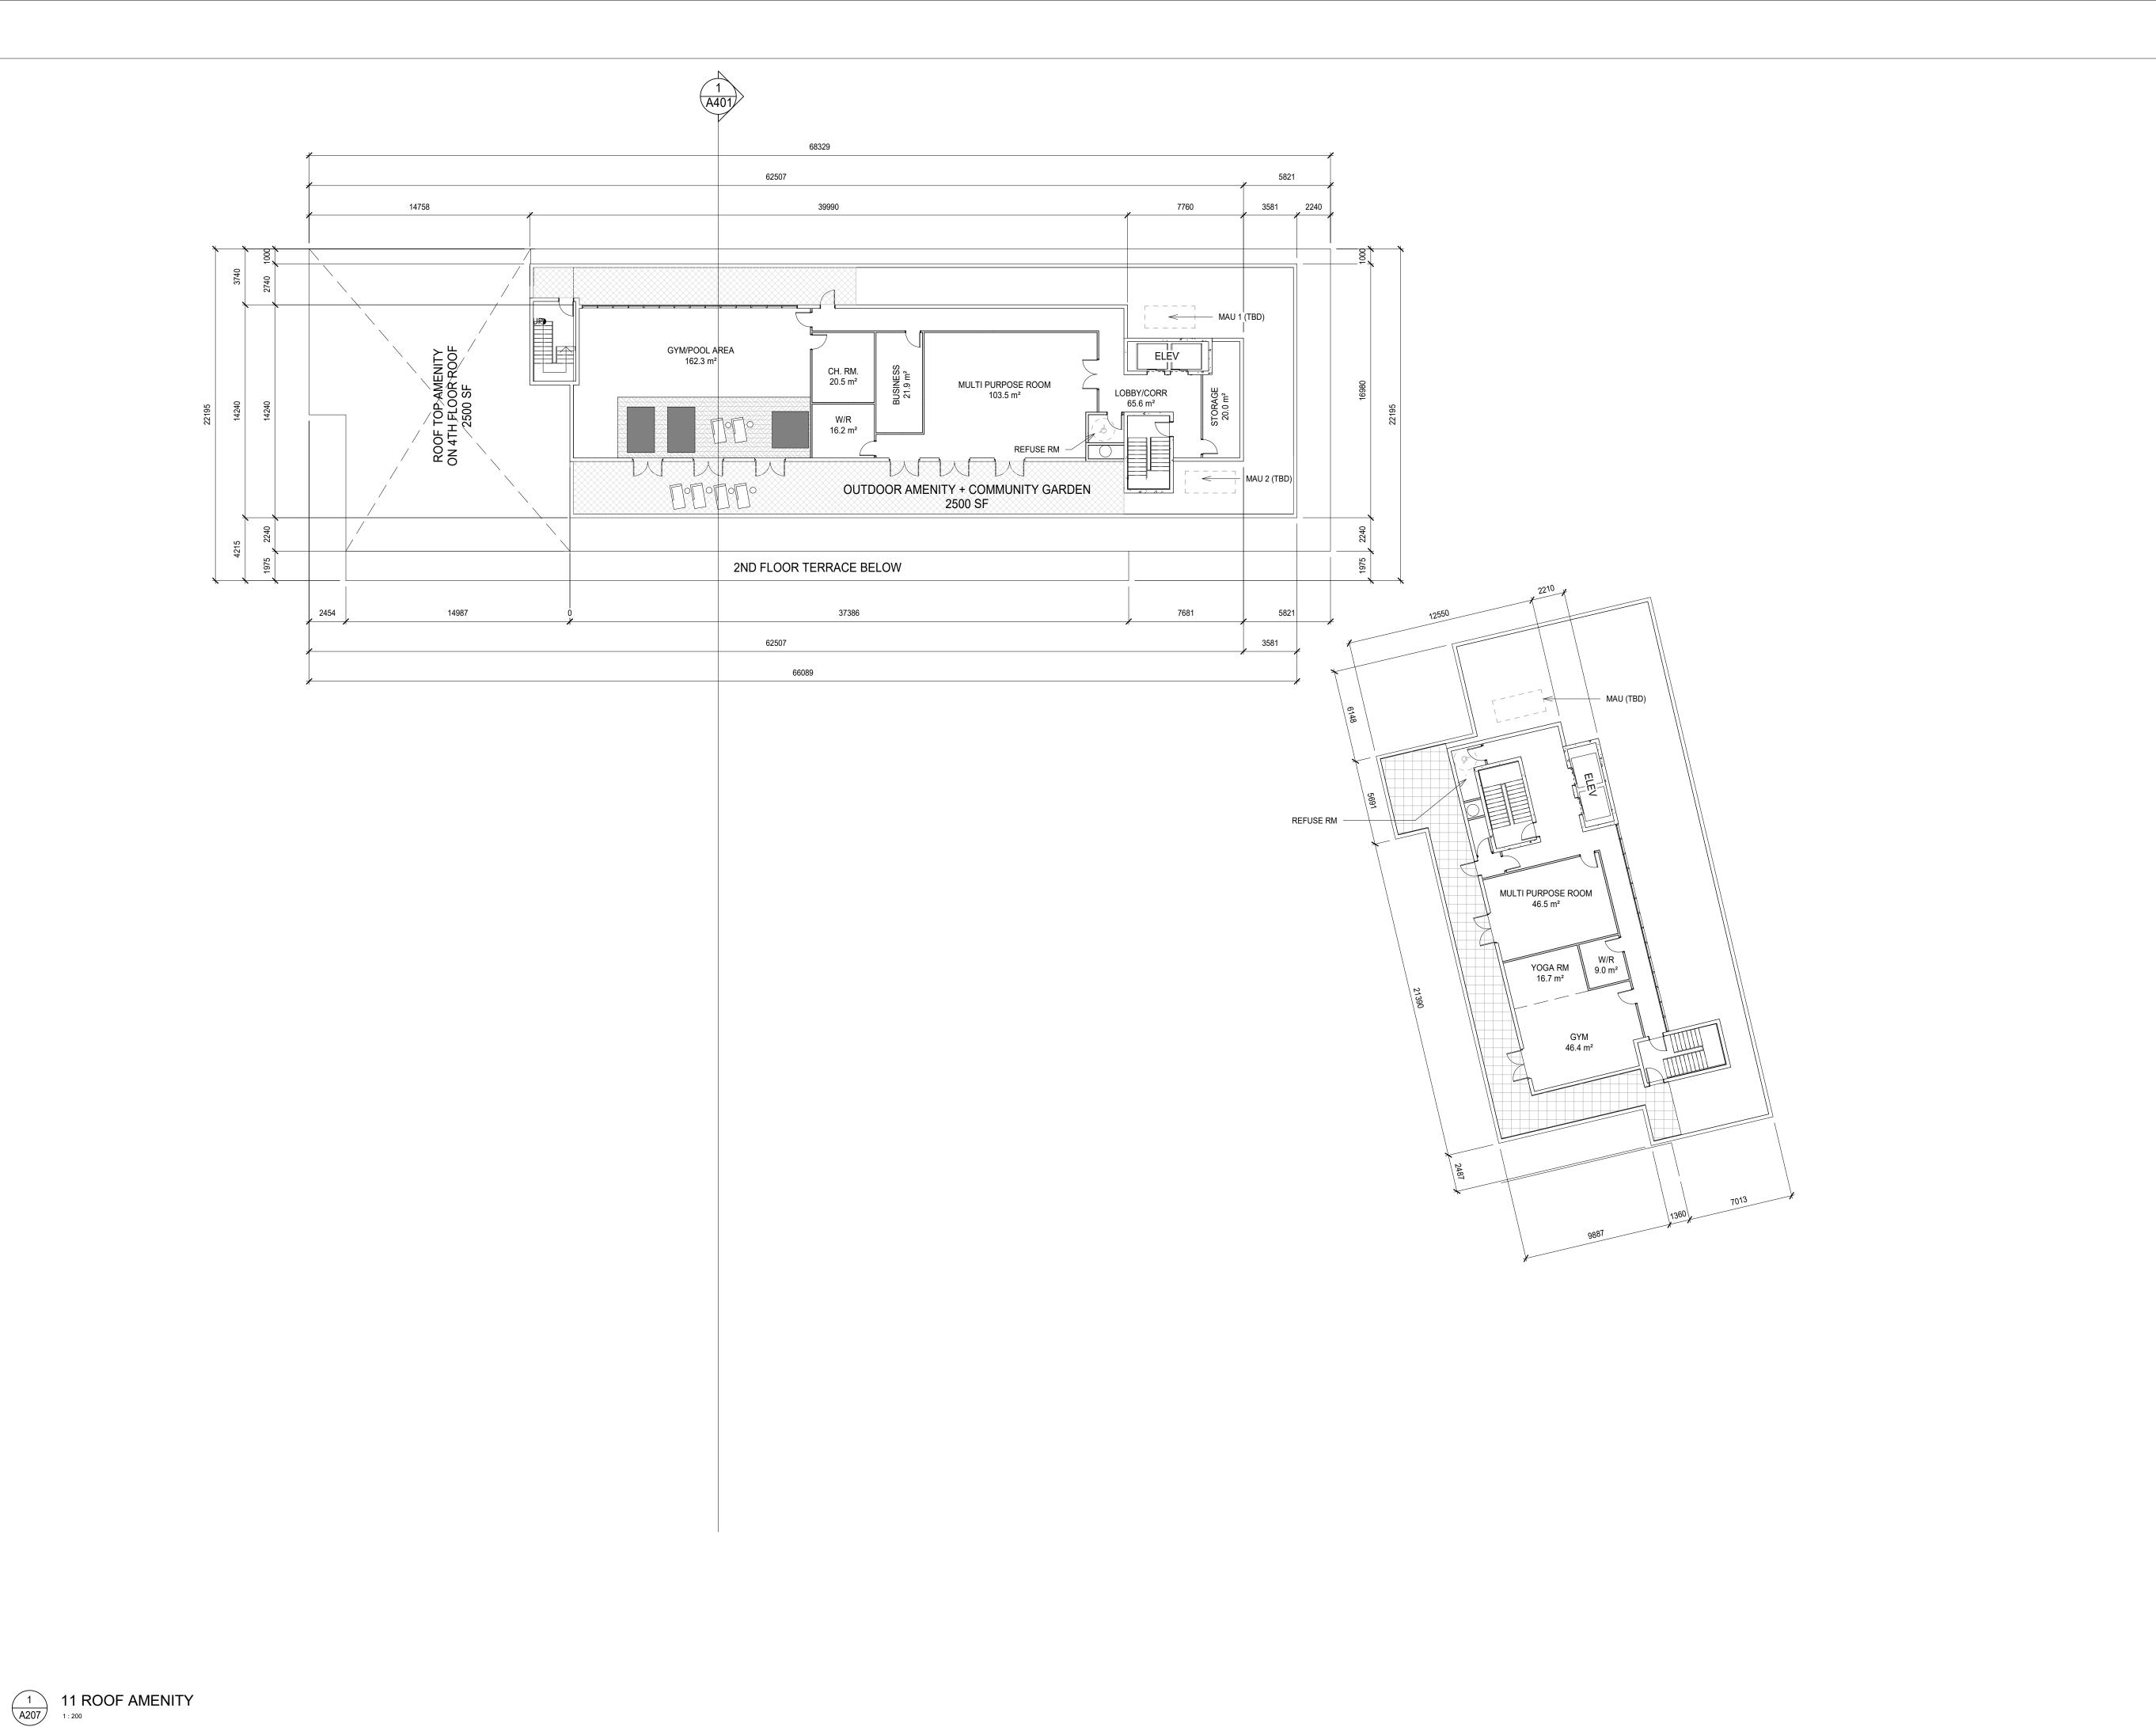

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N0.	REVISIONS	DATE	BY

#### PROJECT:

## **Proposed Multi-Storey** Residential Development

2345-2349 Highway #2, Bowmanville, ON

2779471 Ontario Inc.

#### DRAWING:

#### **ROOF TOP AMENITY**



ARCHITECTS


BARRY BRYAN ASSOCIATES Architects Engineers Project Managers

Designer DRAWN BY: Author CHECKED BY: Checker 201-250 Water Street Whitby Ontario L1N 0G5

13/04/20 SCALE: 1:200

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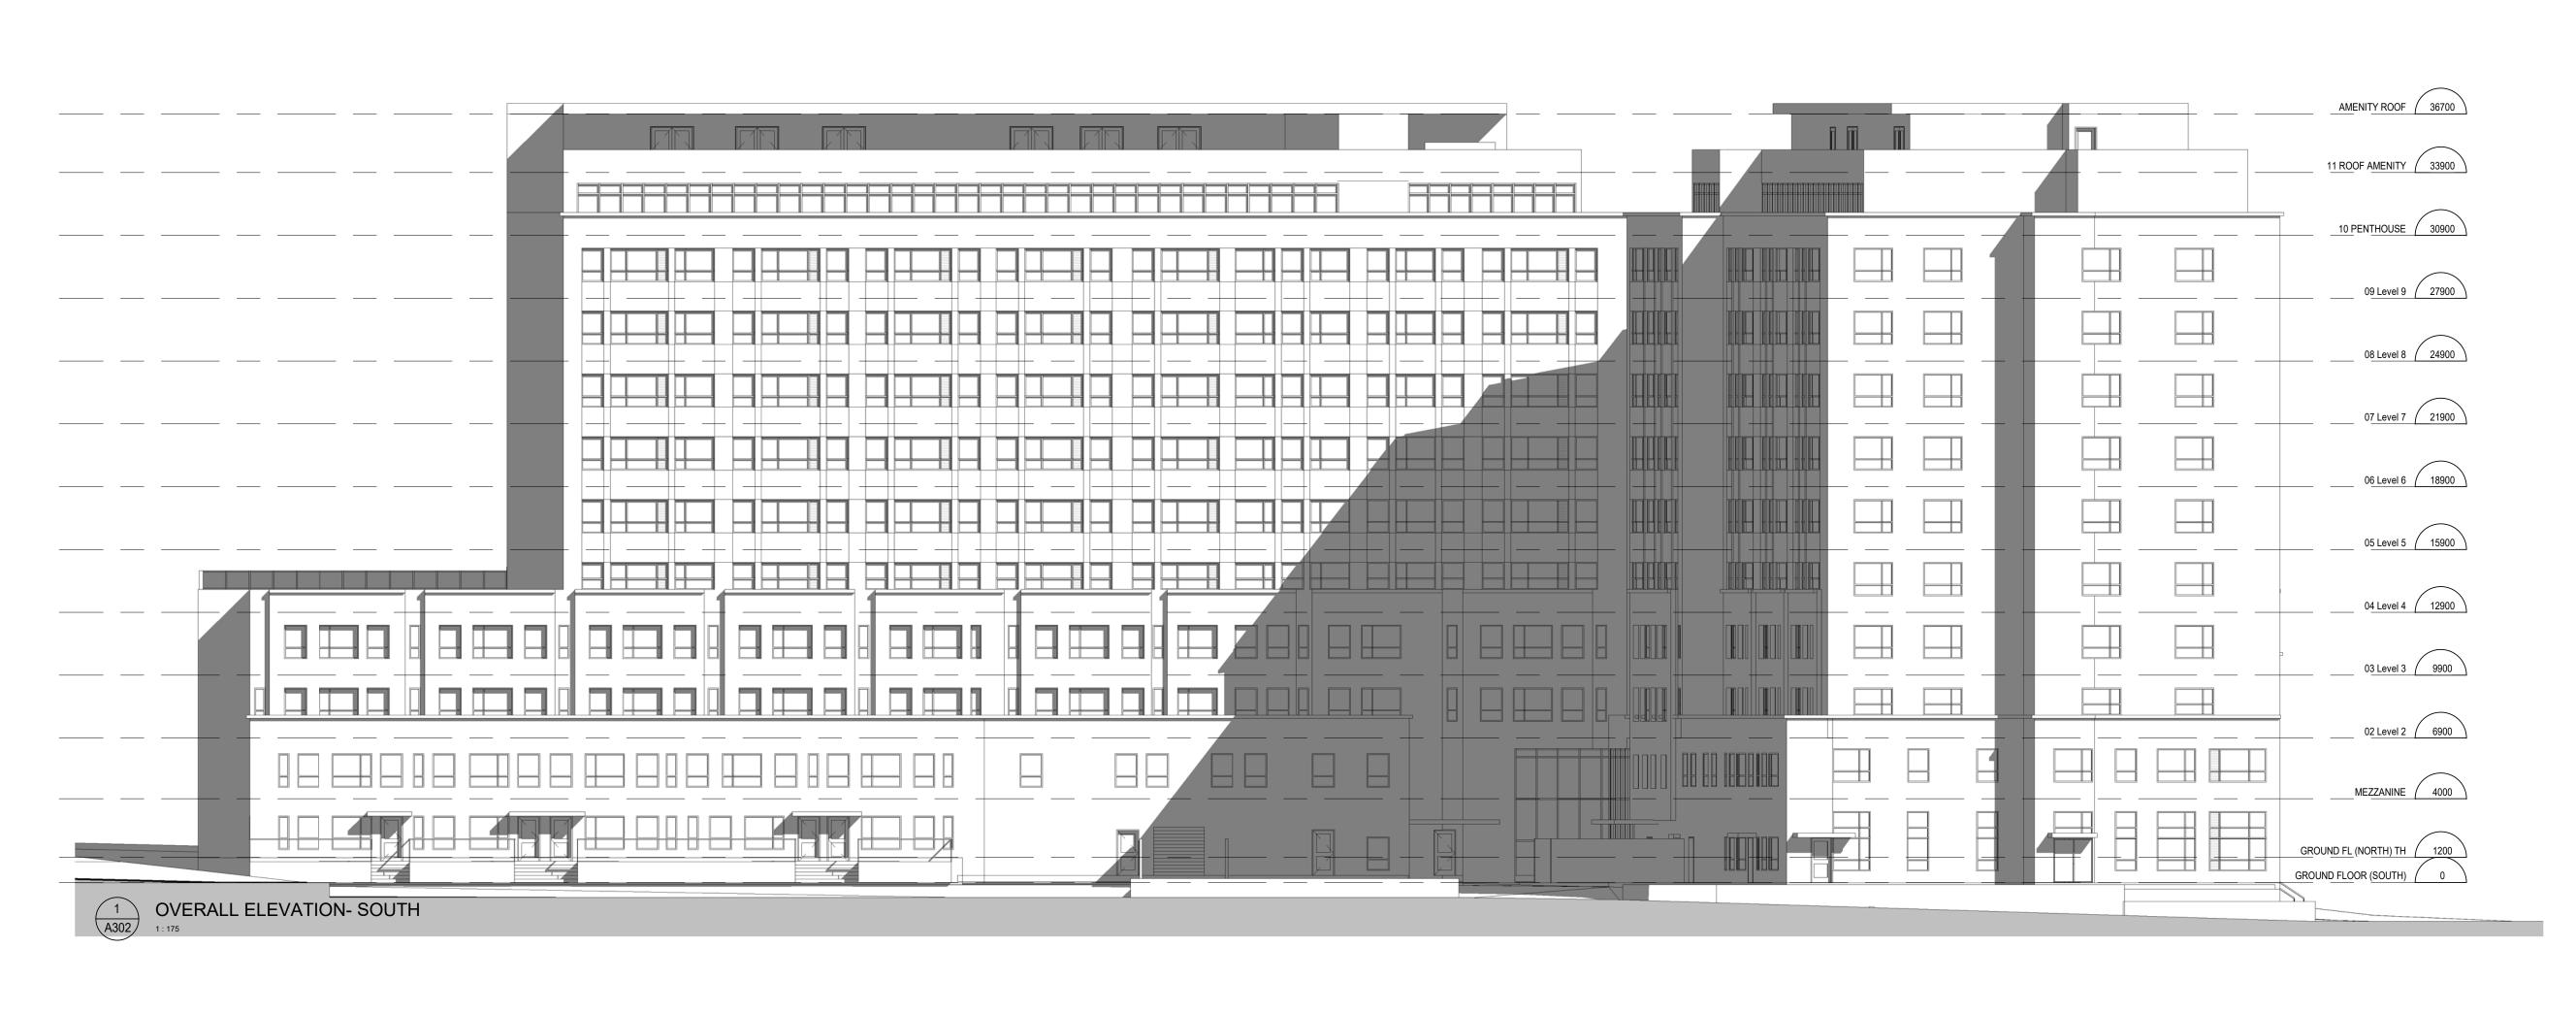
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DATE BY SITE PLAN PRE CONSULTATION Jul 15, 20 RG Sep 21, 20 RG Sep 29, 20 RG Oct 01, 20 RG Dec 01, 20 RG Dec 07, 20 RG Jan 25, 21 RG

DATE BY
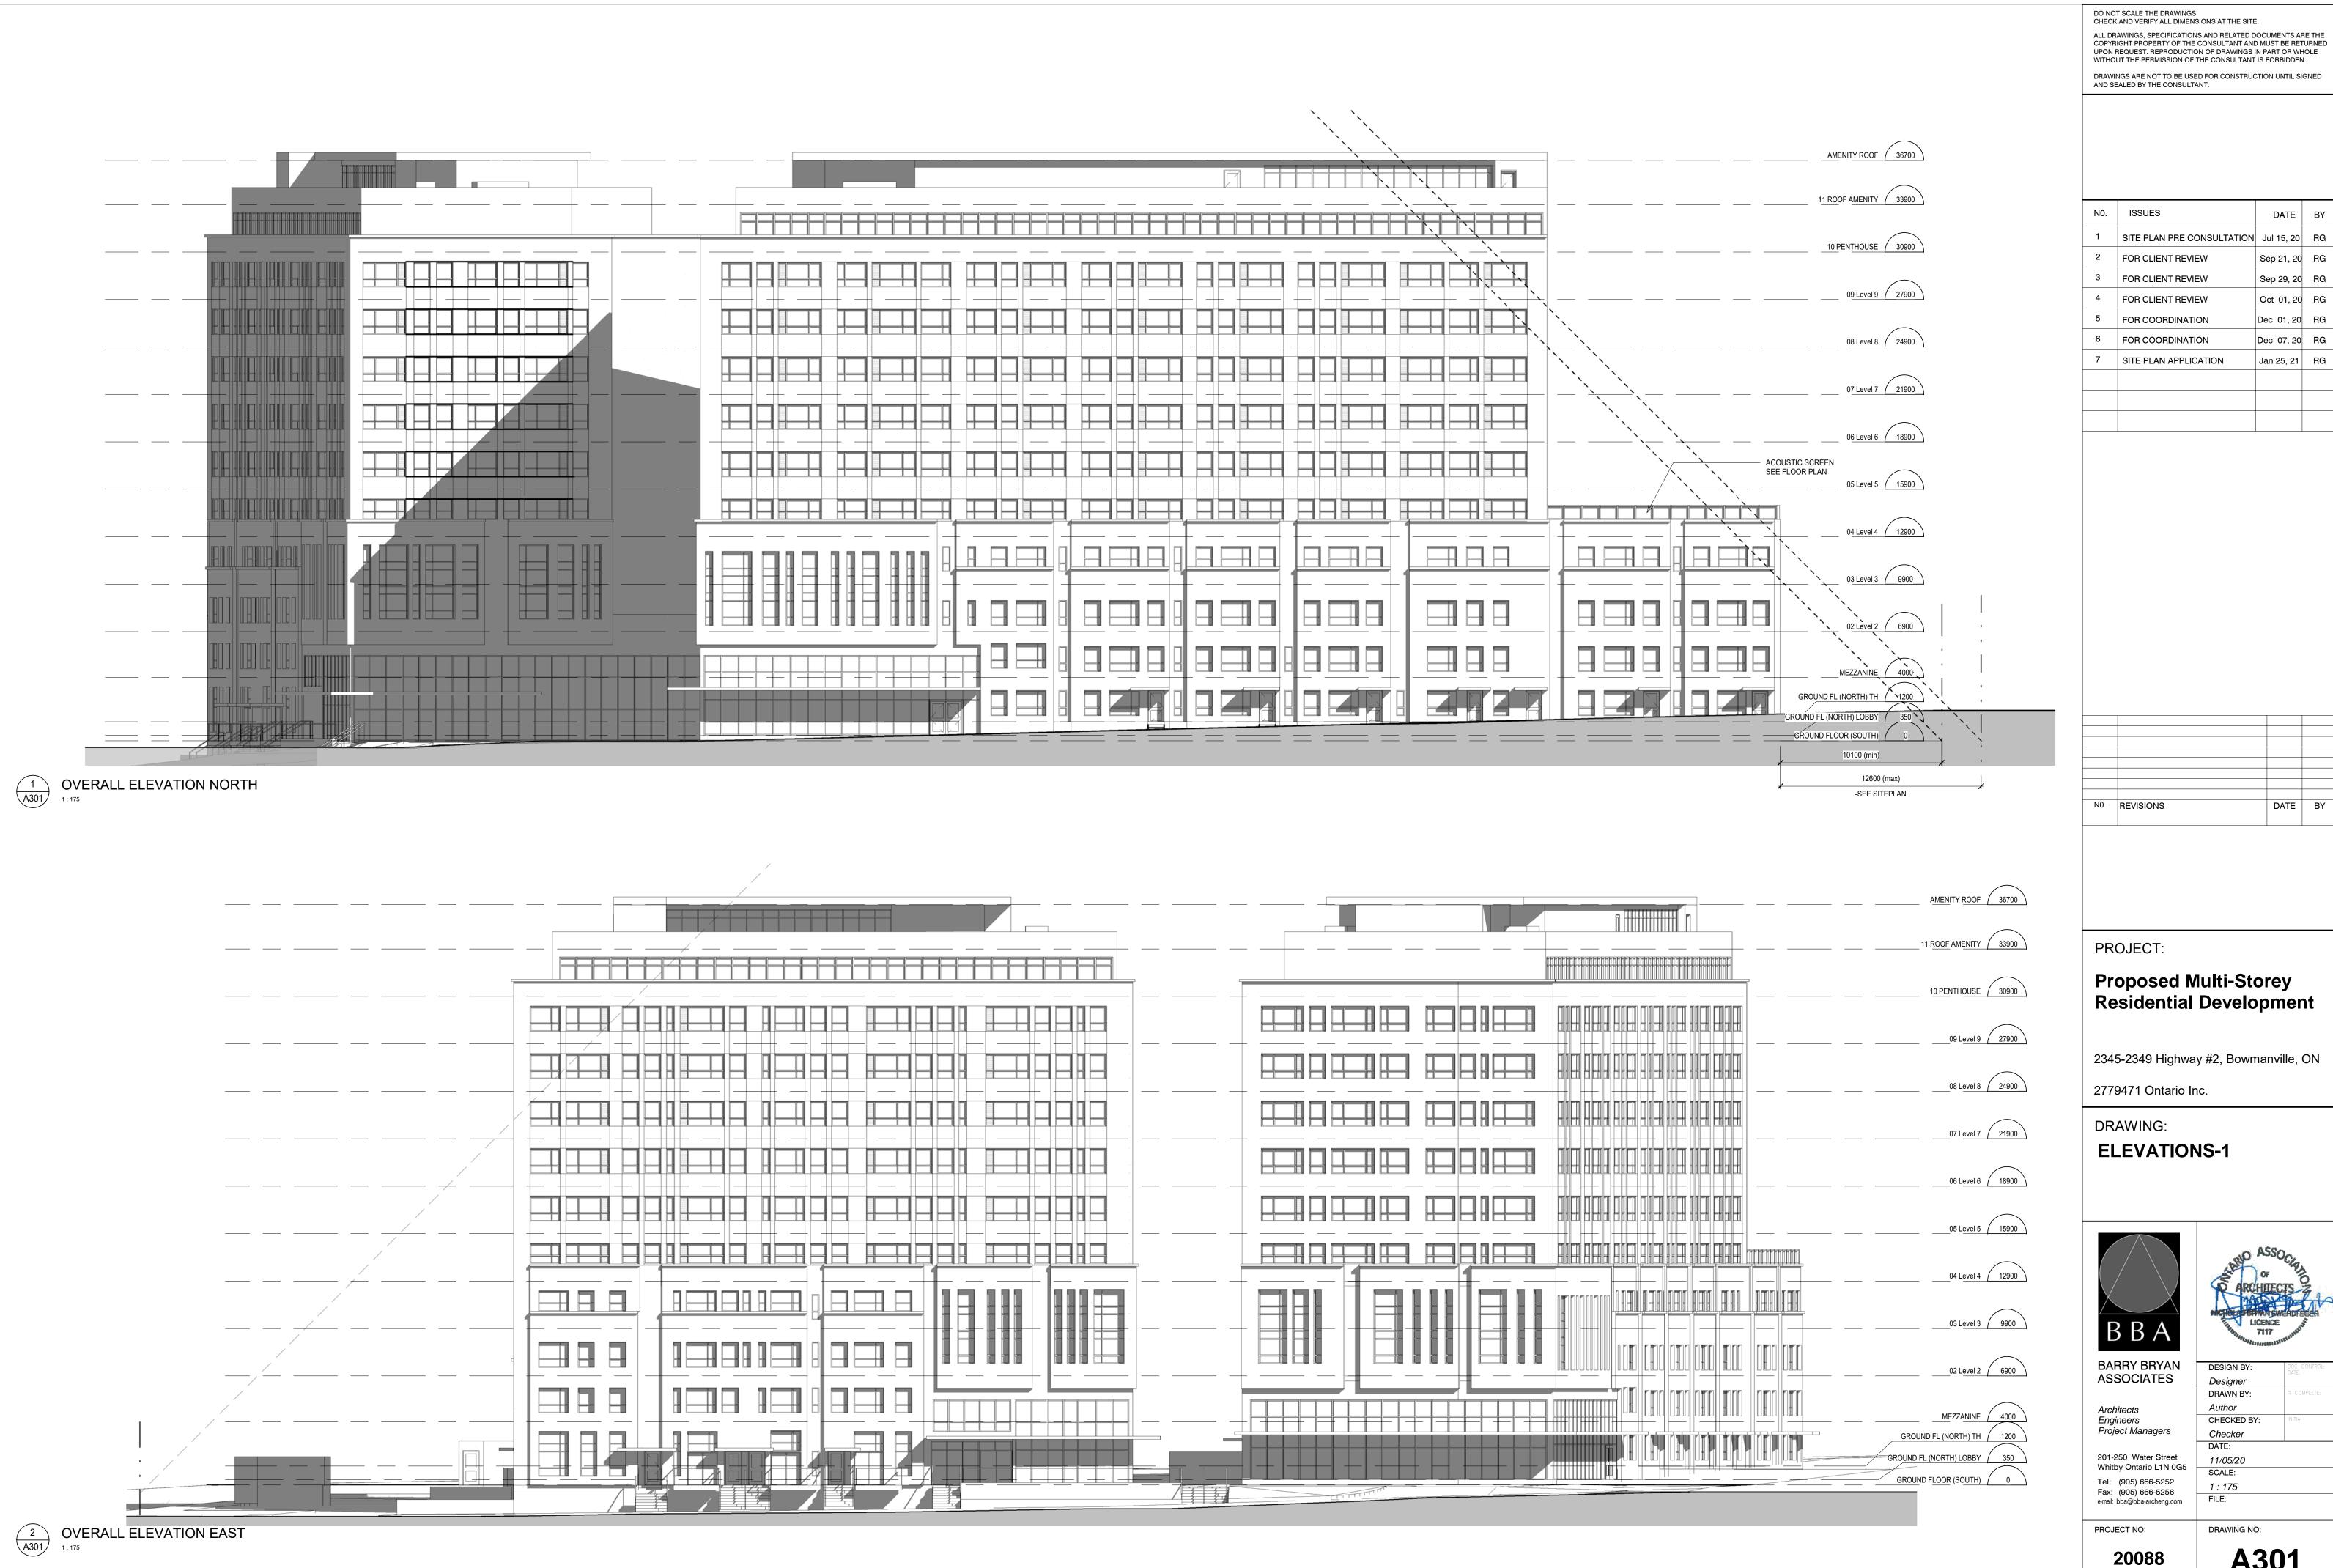
## **Residential Development**







OVERALL ELEVATION-WEST
1:175

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N0.	REVISIONS	DATE	B۱

PROJECT:

#### **Proposed Multi-Storey Residential Development**

2345-2349 Highway #2, Bowmanville, ON

2779471 Ontario Inc.

DRAWING:

**ELEVATIONS-2** 



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BARRY BRYAN ASSOCIATES

Architects Engineers Project Managers

DRAWN BY: **Author** CHECKED BY: 11/05/20

Designer


201-250 Water Street Whitby Ontario L1N 0G5 Tel: (905) 666-5252 Fax: (905) 666-5256 e-mail: bba@bba-archeng.com FILE:

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20088

PROJECT NO:

DRAWING NO: A302

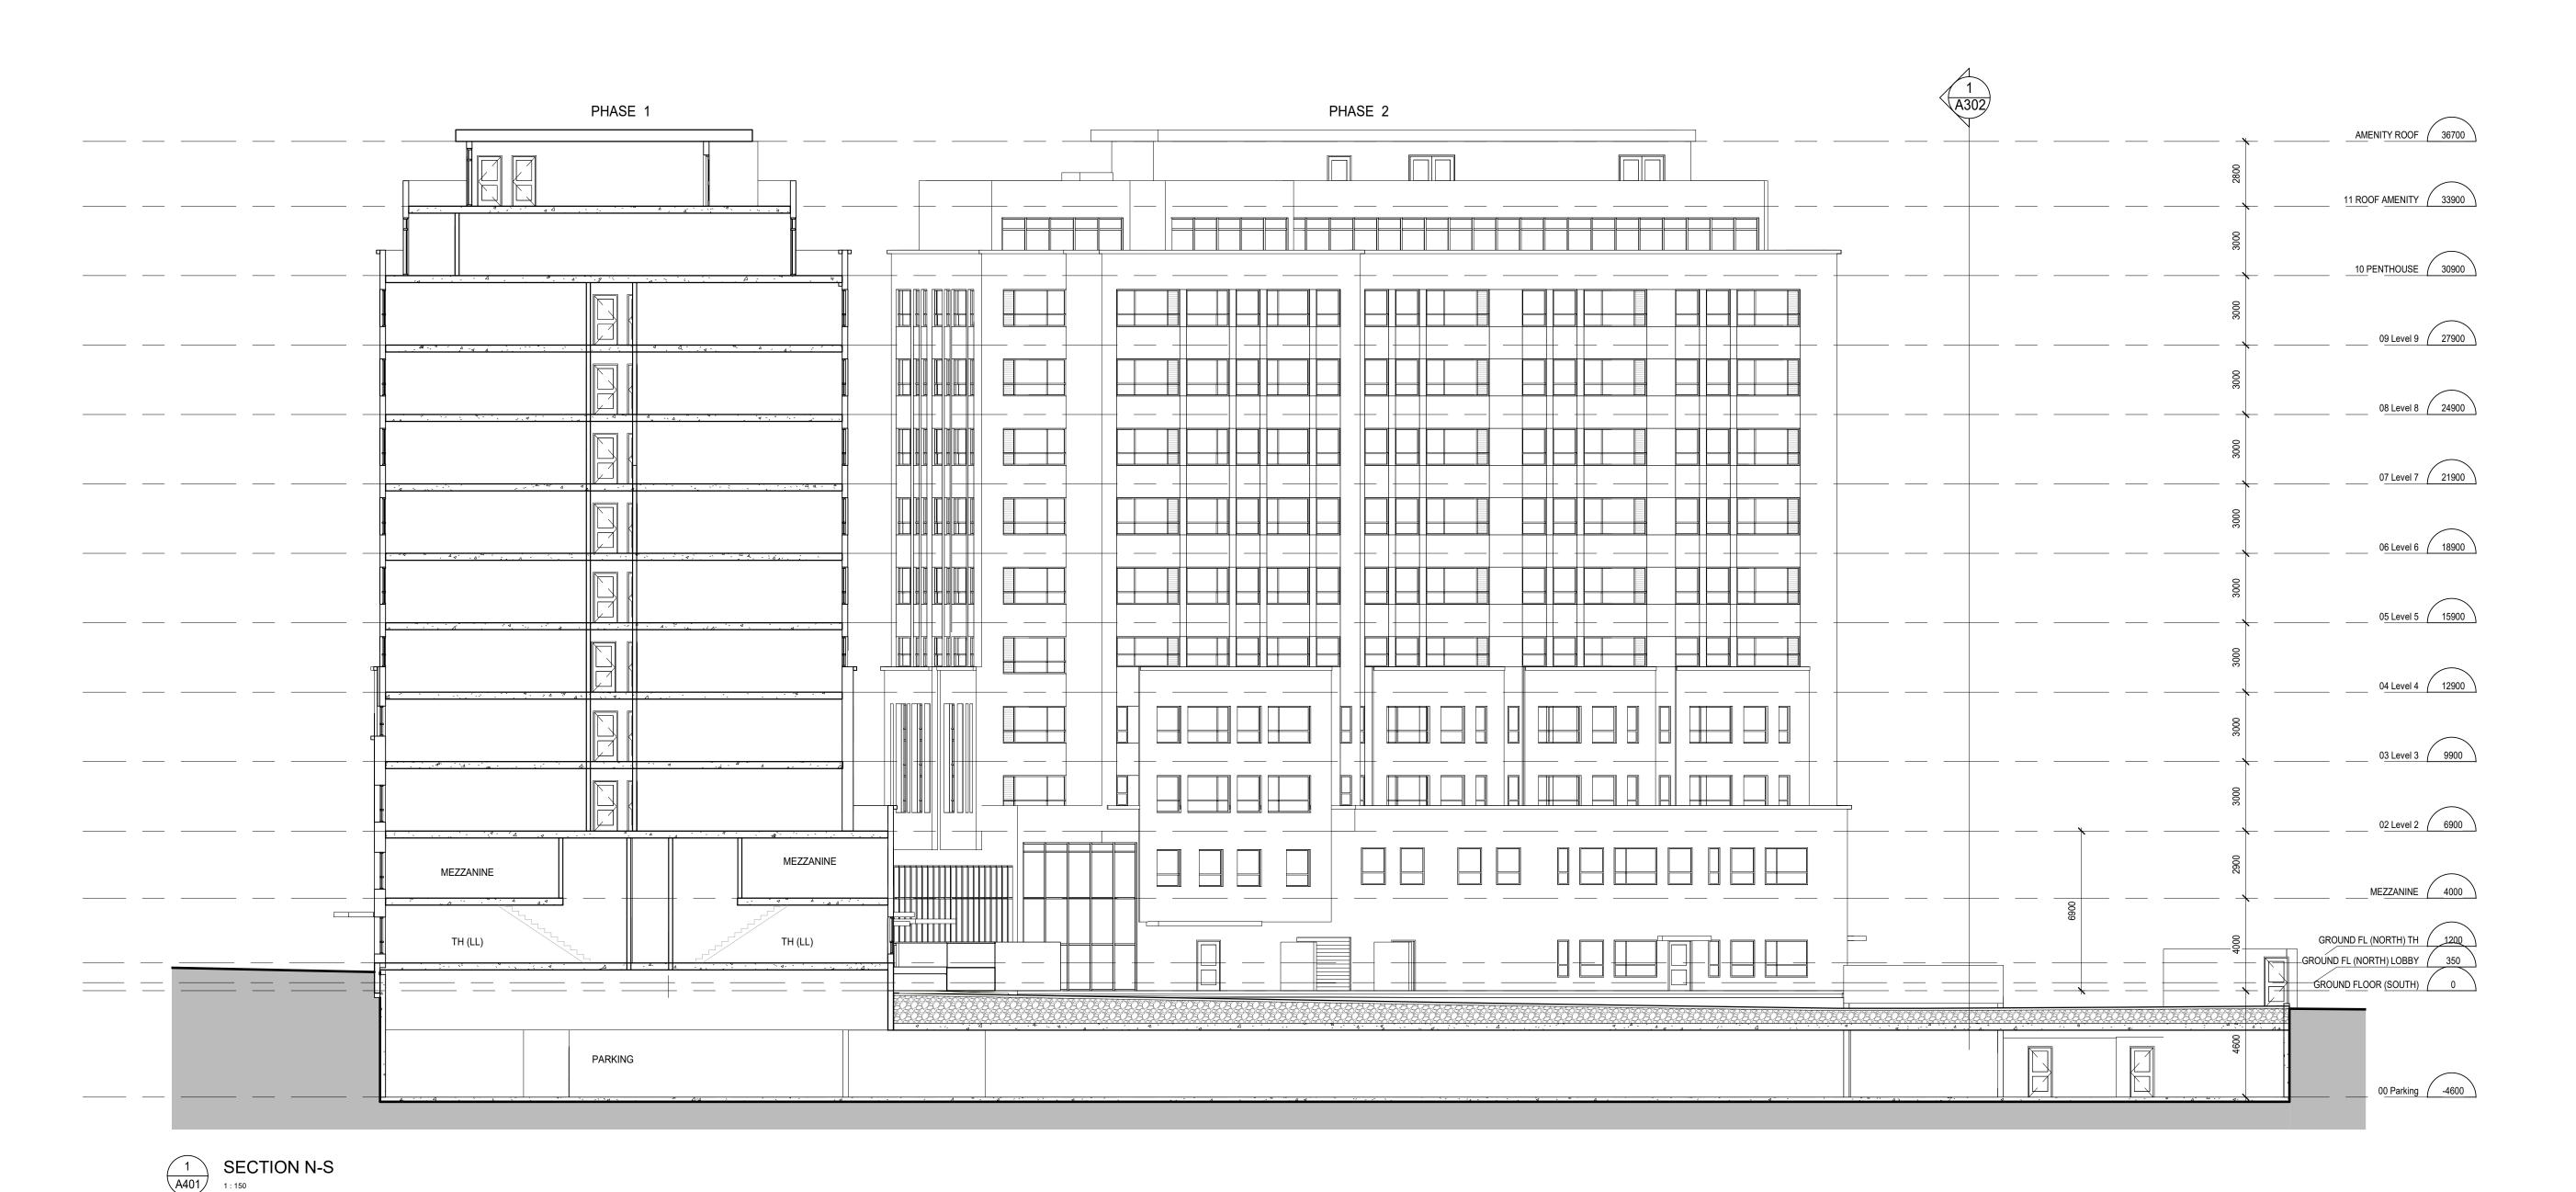

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N0.	REVISIONS	DATE	BY

PROJECT:

# Proposed Multi-Storey Residential Development

2345-2349 Highway #2, Bowmanville, ON

2779471 Ontario Inc.

DRAWING:

#### **BUILDING SECTION**






BARRY BRYAN ASSOCIATES Architects

Designer
DRAWN BY: **Author** CHECKED BY: Checker

Engineers Project Managers 201-250 Water Street Whitby Ontario L1N 0G5 Tel: (905) 666-5252 Fax: (905) 666-5256 e-mail: bba@bba-archeng.com

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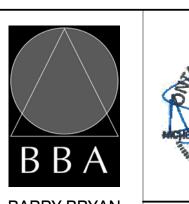
#### **Proposed Multi-Storey Residential Development**

2345-2349 Highway #2, Bowmanville, ON

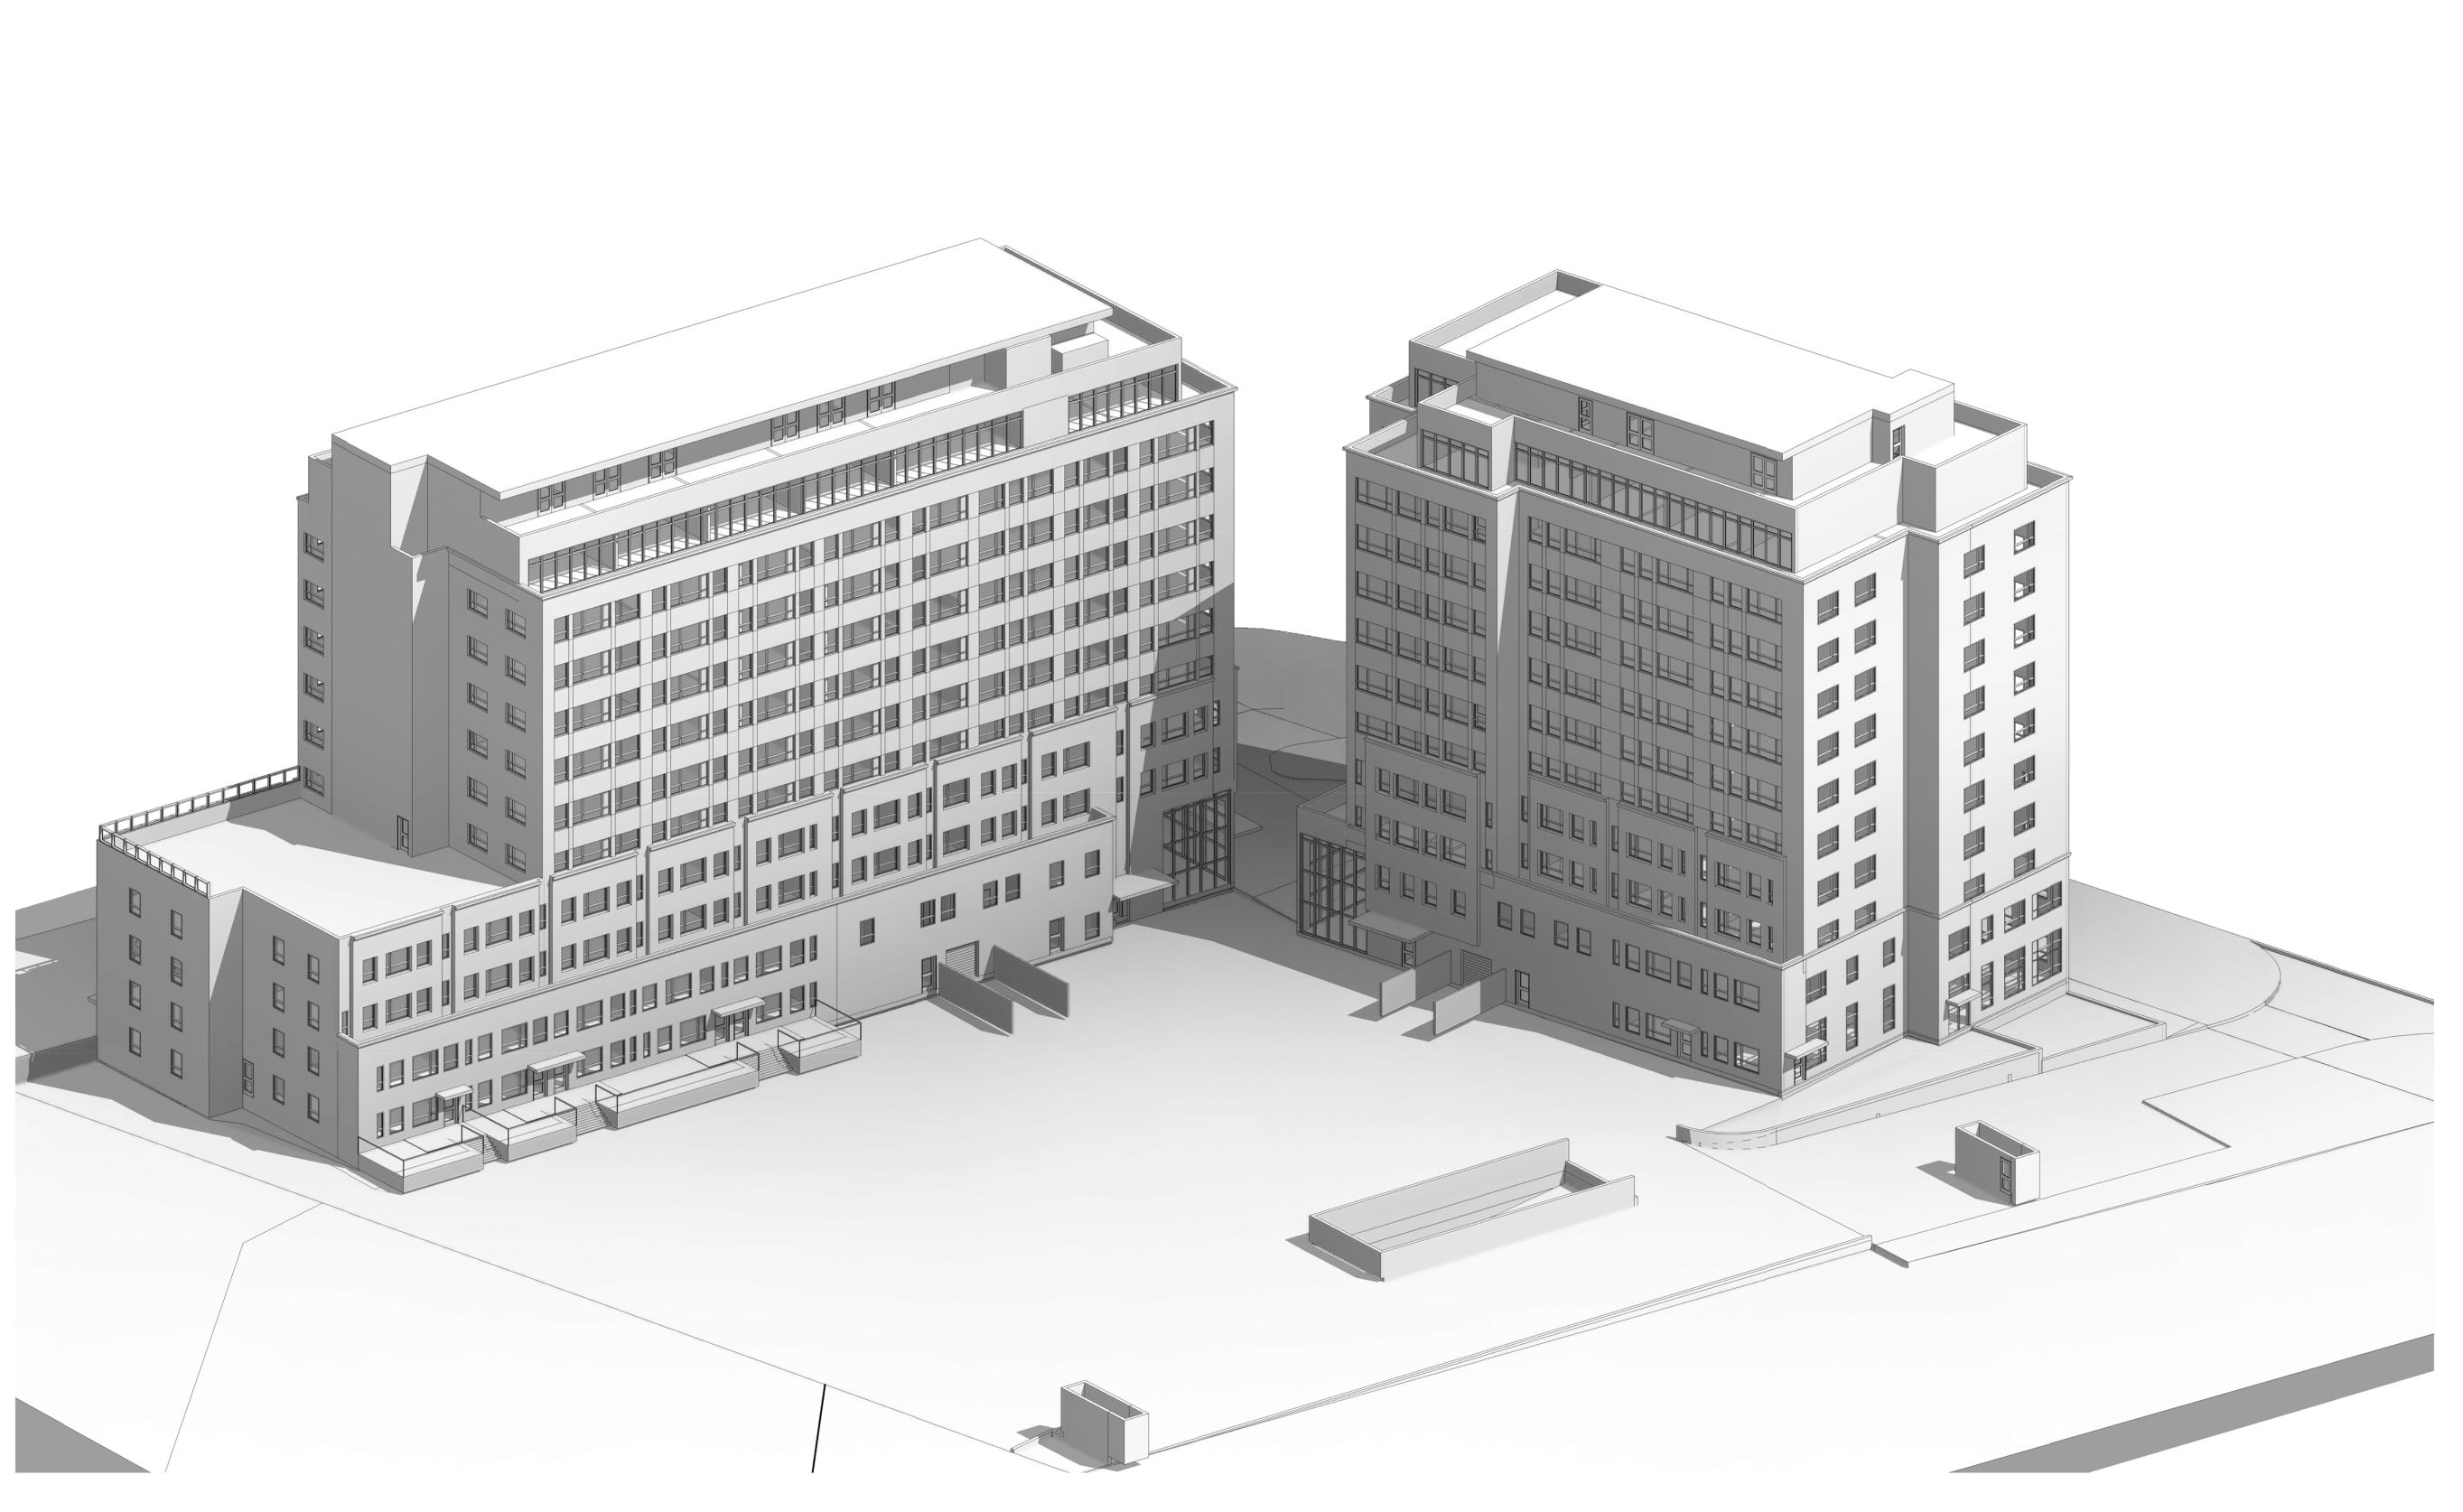2779471 Ontario Inc.

#### DRAWING:

#### **3D VIEW FROM SOUTH-WEST**



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	L
BARRY BRYAN	Γ
COCCIATEO	

ASSOCIATES

Engineers Project Managers

Architects

PROJECT NO:

**Author** 


CHECKED BY:

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DRAWING NO: 20088

A601

1 VIEW from SOUTH-WEST

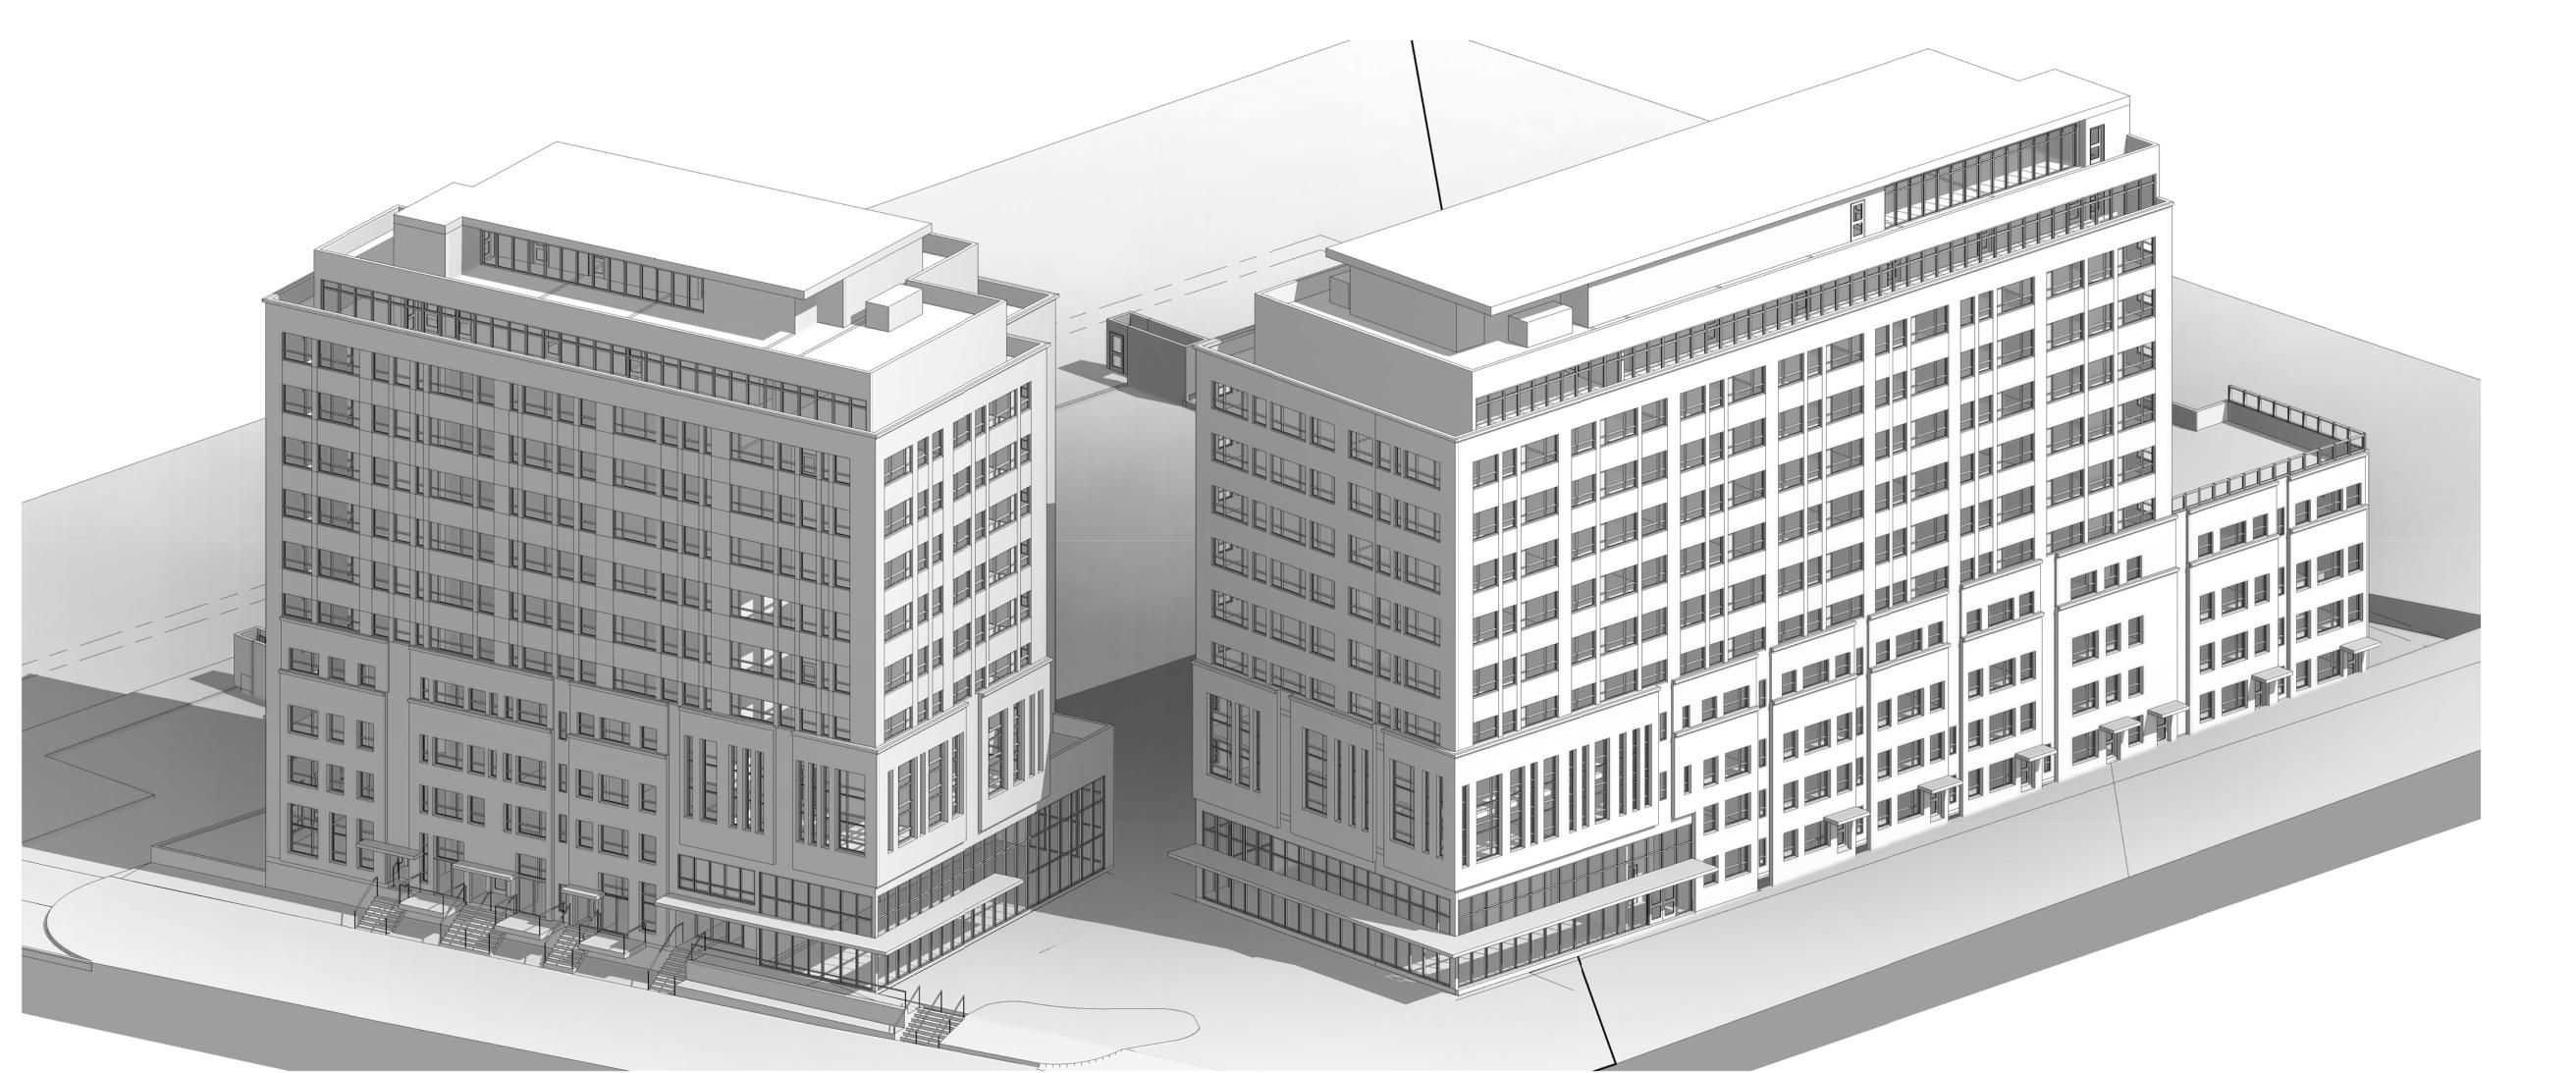

VIEW from NORTH-EAST

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PROJECT:

#### **Proposed Multi-Storey Residential Development**

2345-2349 Highway #2, Bowmanville, ON

2779471 Ontario Inc.

DRAWING:

#### **3D VIEW FROM NORTH-EAST**





BARRY BRYAN ASSOCIATES **Architects** 

Engineers Project Managers

> Tel: (905) 666-5252 Fax: (905) 666-5256


**Author** 201-250 Water Street 13/04/20 Whitby Ontario L1N 0G5

CHECKED BY:

DRAWN BY:

e-mail: bba@bba-archeng.com

PROJECT NO: 20088 DRAWING NO: A602

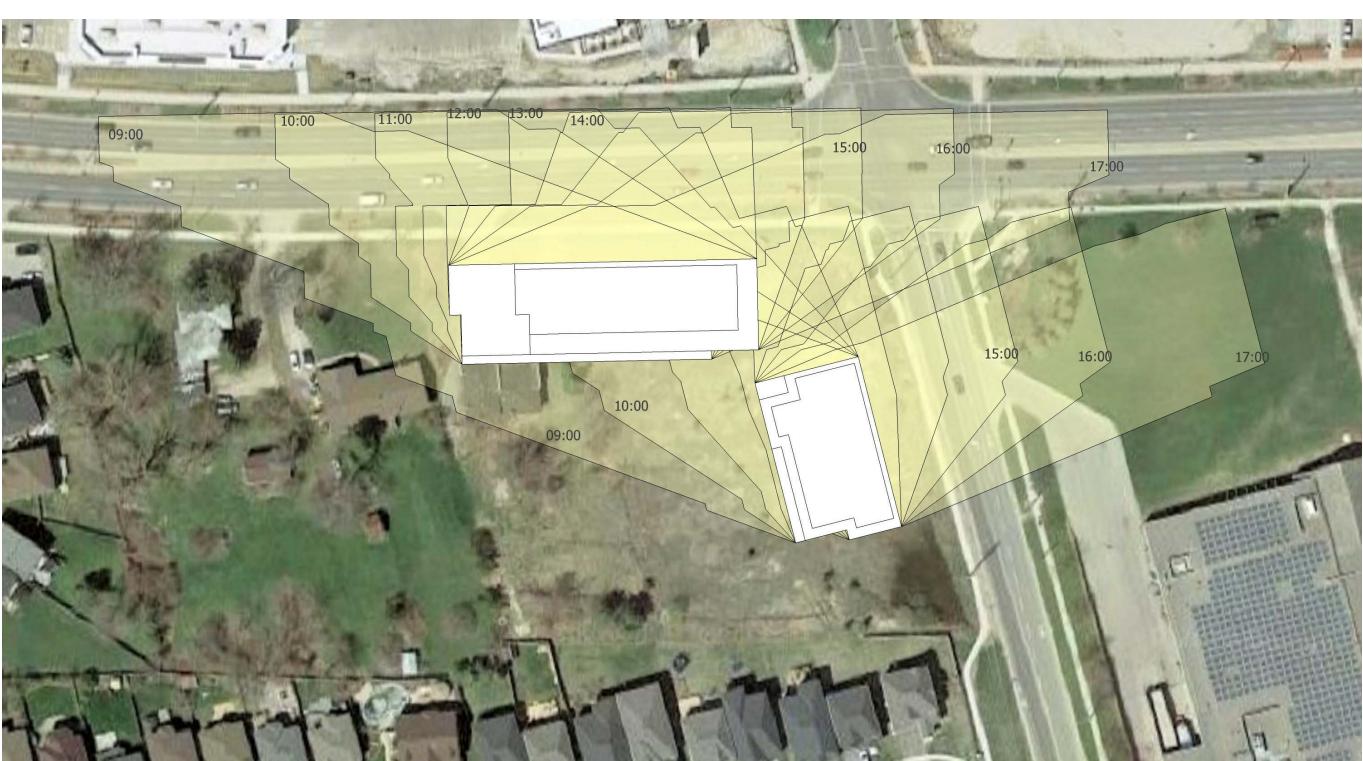

2345-2349 Highway #2, Bowmanville, ON JUNE 21 9:00 am to 5:00pm

2345-2349 Highway #2, Bowmanville, ON MARCH 21 9:00 am to 5:00pm

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6	FOR COORDINATION	Dec 07, 20	RG
7	SITE PLAN APPLICATION	Jan 25, 21	RG

N0.	REVISIONS	DATE	BY

#### PROJECT:

17:00

# Proposed Multi-Storey Residential Development

2345-2349 Highway #2, Bowmanville, ON

2779471 Ontario Inc.

#### DRAWING: **SHADOW IMAPCT**





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DESIGN BY:	DOC CONTROL:
Designer	
DRAWN BY:	% COMPLETE:
Author	


BRYAN	DESIGN BY:	DOC (
IATES	Designer	
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	Author	
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anagers	Checker	
	DATE:	
ater Street	01/26/21	

Architects Engineers Project Mar 201-250 Water Street
Whitby Ontario L1N 0G5

01/26/21
SCALE: Tel: (905) 666-5252 Fax: (905) 666-5256 e-mail: bba@bba-archeng.com

DRAWING NO: PROJECT NO:

A701 20088

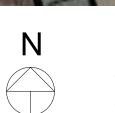


2345-2349 Highway #2, Bowmanville, ON SEPTEMBER 21 9:00 am to 5:00pm


## AREA STATEMENT

PHASE-1 Area Staement						
	Gross Constructed Area(sqft)	Exclusion-1	Exclusion-2	Exclusion-3	Exclusion-4	Salable Area (sqft)
		PARKING	ACCESSORY SPACE	AMENITY	SHAFTS	
Parking	53,574	53,574				10
Total (parking)	53,574					0
Ground Floor						
Residential	13,727		5,160	0	118	8,449
Commercial	2,076		0	0	0	2,076
Mezzanine	6,032		0	0	0	6,032
Storage (Mezzanine)	2,156		60	0	115	1,981
Level-2	14,625		1,687	0	115	12,823
Level-3	14,625		1,687	0	115	12,823
Level-4	11,397		1,575	0	115	9,707
Level-5	11,397		1,575	0	115	9,707
Level-6	11,397		1,575	0	115	9,707
Level-7	11,397		1,575	0	115	9,707
Level-8	11,397		1,575	0	115	9,707
Level-9	11,397		1,575	0	115	9,707
Level-10 PENTHOUSE	9,126		1,904	0	115	7,107
LEVEL-11 Roof top Amenity	5,221		1,267	3,839	115	
Total (excluding Parking)	135,970		21,215	3,839	1,383	109,533


Efficiency (including Amenity)

80.6%

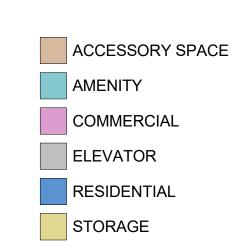


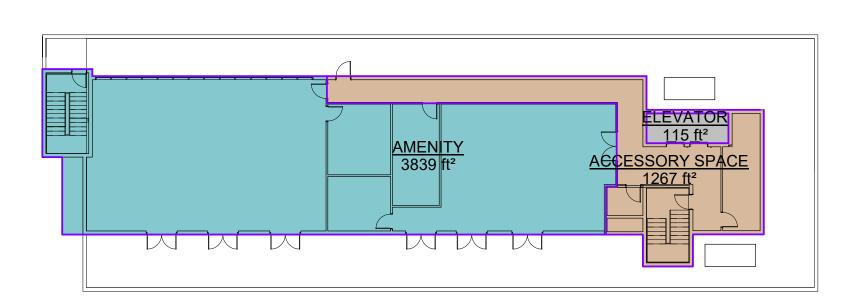


6 PHASE1-LEVEL 11- ROOF AMENITY

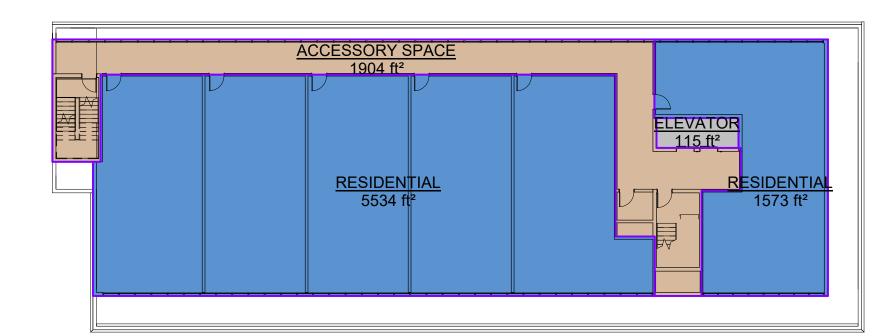



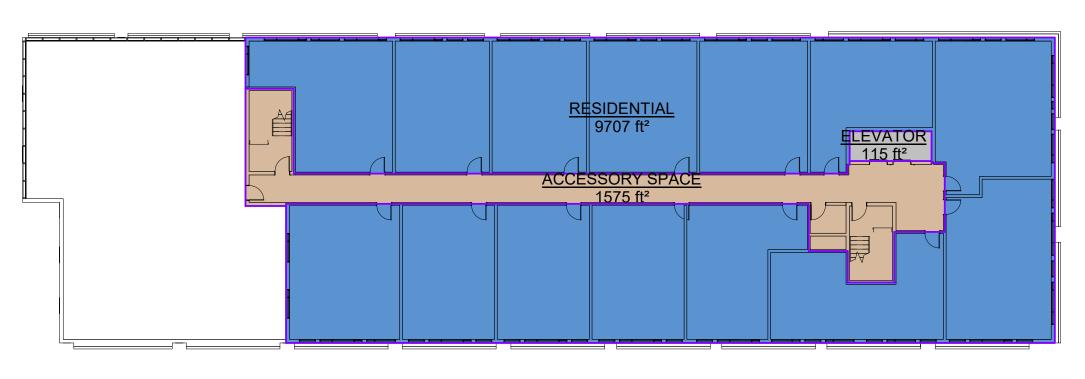

4 PHASE1-LEVELS 4-9

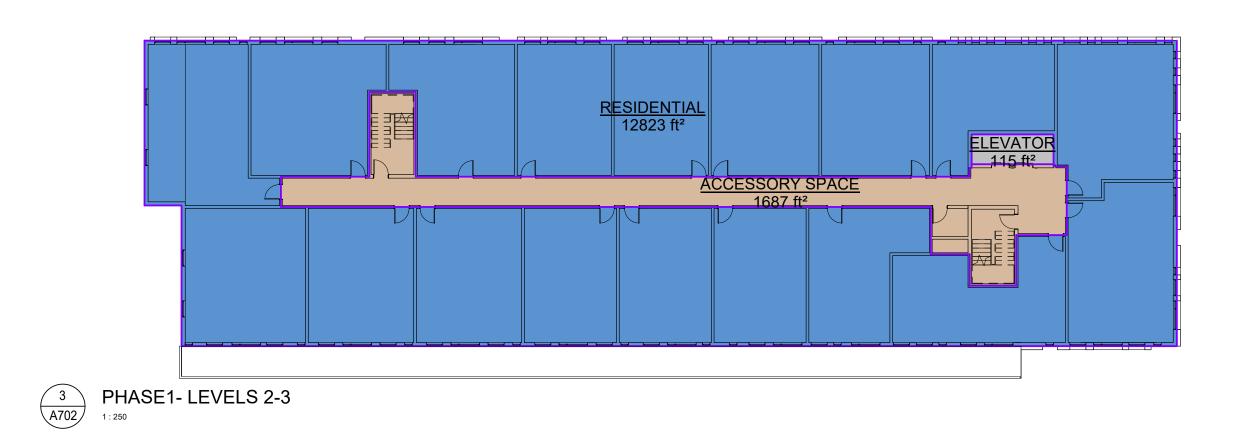







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N0.	REVISIONS	DATE	BY

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# Proposed Multi-Storey Residential Development

2345-2349 Highway #2, Bowmanville, ON

2779471 Ontario Inc.

#### DRAWING:

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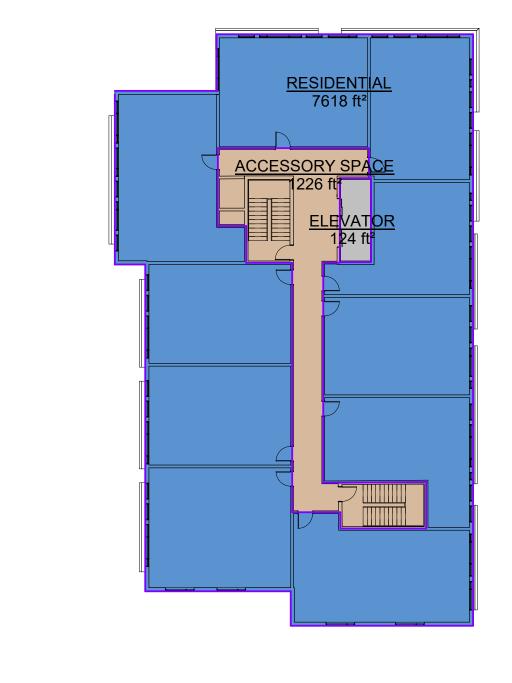
#### **AREA PLANS-PHASE 1**



#### AREA STATEMENT


PHASE-2	Area Staement					
	Gross Constructed Area(sqft)	Exclusion-1	Exclusion-2	Exclusion-3	Exclusion-4	Salable Area (sqft)
		PARKING	ACCESSORY SPACE	AMENITY	SHAFTS	
Parking	28,428	28,428				
Total (parking)	28,428					
Ground Floor						
Residential	7,776		1,782		124	5,87
Commercial	1,922					1,92
Mezzanine	3,299					3,29
Storage(mezzanine)	1,564		74		124	1,36
Level-2	8,973	¢	1,231		124	7,61
Level-3	8,973		1,231		124	7,61
Level-4	8,973		1,231		124	7,61
Level-5	8,973		1,231		124	7,61
Level-6	8,973		1,231		124	7,61
Level-7	8,973		1,231		124	7,61
Level-8	8,973		1,231		124	7,61
Level-9	8,973		1,231		124	7,61
Level-10 PENTHOUSE	6,577		1,489		124	4,96
LEVEL-11 Roof top Amenity	2,681		1,242	1,305	134	
Total (excluding Parking)	95,603		14,435	1,305	1,498	78,36


Efficiency (including Amenity) 82.0%




4 PHASE2-LEVEL4-9



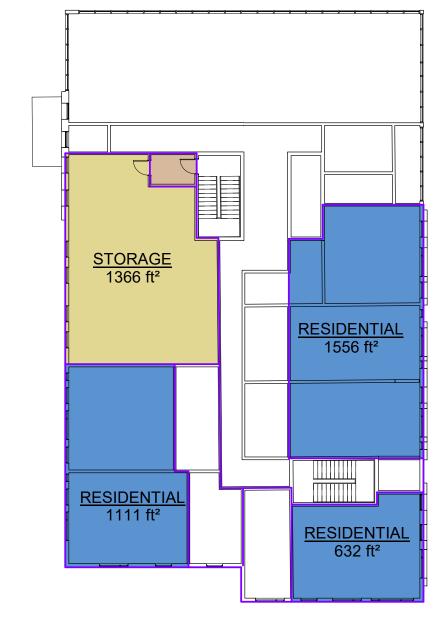

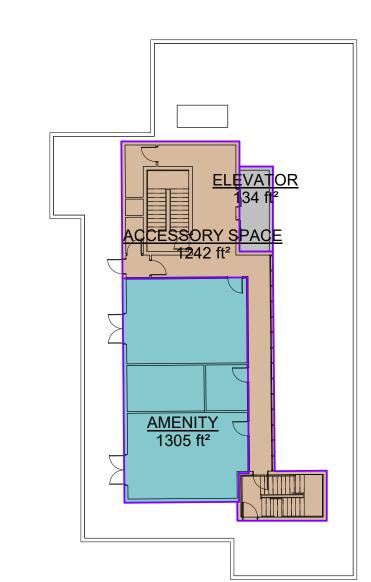



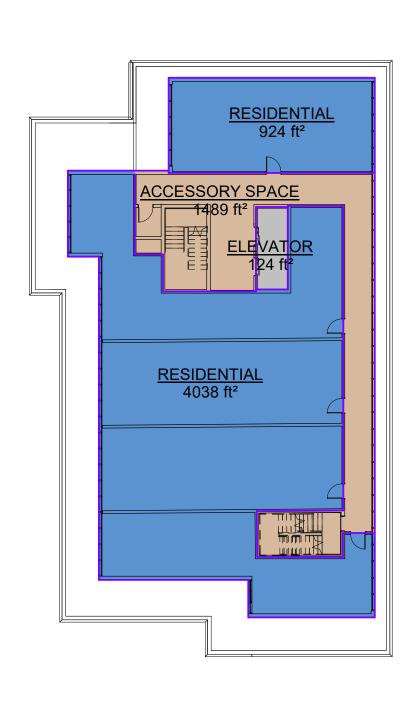

ACCESSORY SPACE


AMENITY

ELEVATOR


STORAGE

RESIDENTIAL



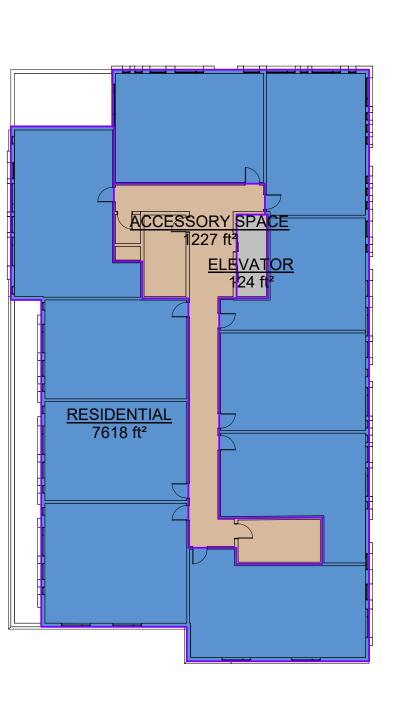



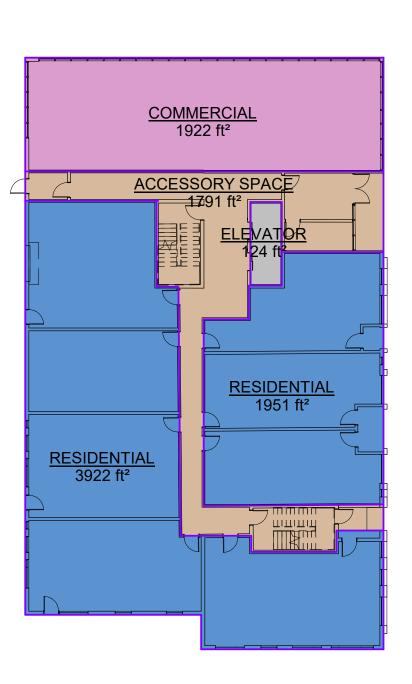

1 PHASE2-LEVEL 1- GROUND FLOOR

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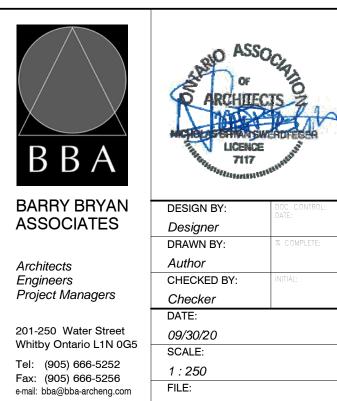
#### **Proposed Multi-Storey** Residential Development

2345-2349 Highway #2, Bowmanville, ON

2779471 Ontario Inc.

#### DRAWING:

#### **AREA PLANS-PHASE 2**



	DATE:
0 Water Street Ontario L1N 0G5	09/30/20
Oniano Em ogo	SCALE:
905) 666-5252 905) 666-5256	1 : 250
pa@bba-archeng.com	FILE:

PROJECT NO: DRAWING NO: